

1. SEE SPECIFICATION SECTION 010110IC FOR INFECTION CONTROL DESIGN REQUIREMENTS.
2. SEE SHEET A000.1 FOR BUILDING 111 FIRST FLOOR & BASEMENT LEVEL STATEMENT OF CONDITIONS DRAWINGS.
3. THE INTENT OF INFECTION CONTROL (IC) ISOLATION IS TO PROTECT PATIENTS IN THE HOSPITAL WHICH HAVE LOW IMMUNE LEVELS. THEREFORE, CONSTRUCTION OPERATIONS NEED TO BE DIRECTED TO CONTAIN DUST AND PARTICULATE MATTER TO THE CONSTRUCTION AREA. CONSTRUCTION AREA PERIMETER NEEDS TO BE SEALED COMPLETELY WITH MIN 4 MIL POLY AND DUCT TAPE DURING CLASS II, III, OR IV OPERATIONS.
4. PROVIDE TRIAKE ISOLATION MONITORS DURING CLASS III OR CLASS IV CONSTRUCTION OPERATIONS. EACH AREA TO BE UNDER NEGATIVE PRESSURE (0.02"WC) DURING THESE OPERATIONS. MONITOR TO MEASURE PRESSURE DIFFERENTIAL BETWEEN CONSTRUCTION AREA AND ADJACENT CORRIDOR OR ROOM AS DIRECTED BY VA COR
5. DURING CONSTRUCTION OPERATIONS IN EACH ENCLOSED AREA USE TRIAKE ISOLATION MONITORS, MINIMUM (1) ONE IN AREAS LESS THAN 1000 SF, (2) TWO MINIMUM IN AREAS BETWEEN 1000 SF AND 5000 SF, AND (3) THREE FOR AREAS BETWEEN 5000 SF AND 10000 SF. CONTRACTOR WILL NEED PROVIDE EXISTING POWER CONNECTIONS FOR TRIAKE ISOLATION MONITORS OR PROVIDE TEMPORARY POWER TO TRIAKE ISOLATION MONITORS DURING CONSTRUCTION.
6. PROVIDE BALANCING DAMPER IN THE BRANCH SUPPLY & EXHAUST DUCT WORK SERVING THE AFFECTED AREA. BALANCE AIR FLOW TO PROVIDE NEGATIVE AIR FLOW IN CONSTRUCTION ZONE AT ALL TIMES AS INDICATED BELOW. DAMPERS TO REMAIN IN DUCT AFTER CONSTRUCTION IS COMPLETE AND IS TO BE SECURED IN FINAL BALANCING POSITION PRIOR TO TURNING SYSTEM OVER FOR OCCUPANCY.
7. THE CONTRACTOR SHALL PROVIDE ENOUGH NEGATIVE AIR MACHINES TO COMPLETELY EXCHANGE THE REGULATED AREA AIR VOLUME (4) FOUR ACTUAL TIMES PER HOUR. THE COMPETENT PERSON SHALL DETERMINE THE NUMBER OF UNITS NEEDED FOR EACH REGULATED AREA BY DIVIDING THE CUBIC FEET IN THE REGULATED AREA BY (15) FIFTEEN AND THEN DIVIDING THAT RESULT BY THE ACTUAL CUBIC FEET PER MINUTE (CFM) FOR EACH UNIT TO DETERMINE THE NUMBER OF UNITS NEEDED TO EFFECT (4) FOUR AIR CHANGES PER HOUR. PROVIDE A STANDBY UNIT IN THE EVENT OF MACHINE FAILURE AND/OR EMERGENCY IN AN ADJACENT AREA.
8. AS CONSTRUCTION PROGRESSES FROM TYPE D TO TYPE C (SEE SPECIFICATION SECTION "INFECTION CONTROL") AND THEREON, REQUEST A NEW "INFECTION CONTROL CONSTRUCTION PERMIT" FROM THE VA INFECTION CONTROL NURSE. UPON AUTHORIZATION, PROCEED TO NEXT TYPE OF CONSTRUCTION. PROVIDE AT LEAST 10 DAYS NOTICE FOR EACH PERMIT.
9. CONSTRUCT IC (INFECTION CONTROL) CONSTRUCTION BARRIER FROM FLOOR TO DECK/FLOOR ABOVE. SEE DETAIL 1F/A000 & SPECIFICATION SECTION 010110CC. EXCEPTION: IF BARRIER IS ADJACENT TO A SMOKE, FIRE, OR EXISTING WALL CONSTRUCTION WHICH WILL NOT BE DEMOLISHED AND TERMINATES TO FLOOR OR DECK ABOVE, THEN CONSTRUCT IC BARRIER FROM FLOOR TO ABOVE CORRIDOR CEILING WITH 6 MIL POLY BEING SEALED ON ALL EDGES: FLOOR, TOP OF WALL, SIDES, AND ALL PENETRATIONS.
10. GENERAL CONTRACTOR SHALL PROVIDE NEW YELLOW CONSTRUCTION ACCESS DOORS AND PROXIMITY CARD READERS AT ALL BARRIERS. MAINTAIN ALL INFECTION CONTROL STANDARDS. CONTROL BARRIERS ARE TO BE INSTALLED AND REMOVED ONLY BEFORE 7:00 A.M. AND AFTER 8:00 P.M. IN OCCUPIED AREAS.
11. PROVIDE BALANCING DAMPERS IN THE MAIN SUPPLY AND EXHAUST DUCT WORK SERVING THESE AREAS. TEMPORARILY BALANCE AIR FLOW TO PROVIDE NEGATIVE AIR FLOW IN CONSTRUCTION ZONE AT ALL TIMES AS INDICATED BELOW. DAMPERS TO REMAIN IN DUCT AFTER CONSTRUCTION IS COMPLETE AND IS TO BE SECURED IN FINAL BALANCING POSITION PRIOR TO TURNING SYSTEM OVER FOR OCCUPANCY
12. EGRESS IS TO BE MAINTAINED TO THE STAIRWELLS AT ALL TIMES.
13. PRIOR TO ANY REMOVAL OF SMOKE BARRIER FIRE RATED WALLS, CONSTRUCT NEW SMOKE BARRIER/APPROPRIATE FIRE RATED WALLS PER NEW PLANS OR CONSTRUCT INFECTION CONTROL BARRIER TO ACT AS SMOKE BARRIER.
14. A PORTION OF THE CORRIDOR MAY BE MADE AVAILABLE TO CREATE AN INFECTION CONTROL AREA; HOWEVER, A MINIMUM OF 5 FT MUST BE MAINTAINED OPEN FOR THE MOVEMENT OF PERSONNEL. THE CORRIDOR WILL NOT BE CLOSED OFF.












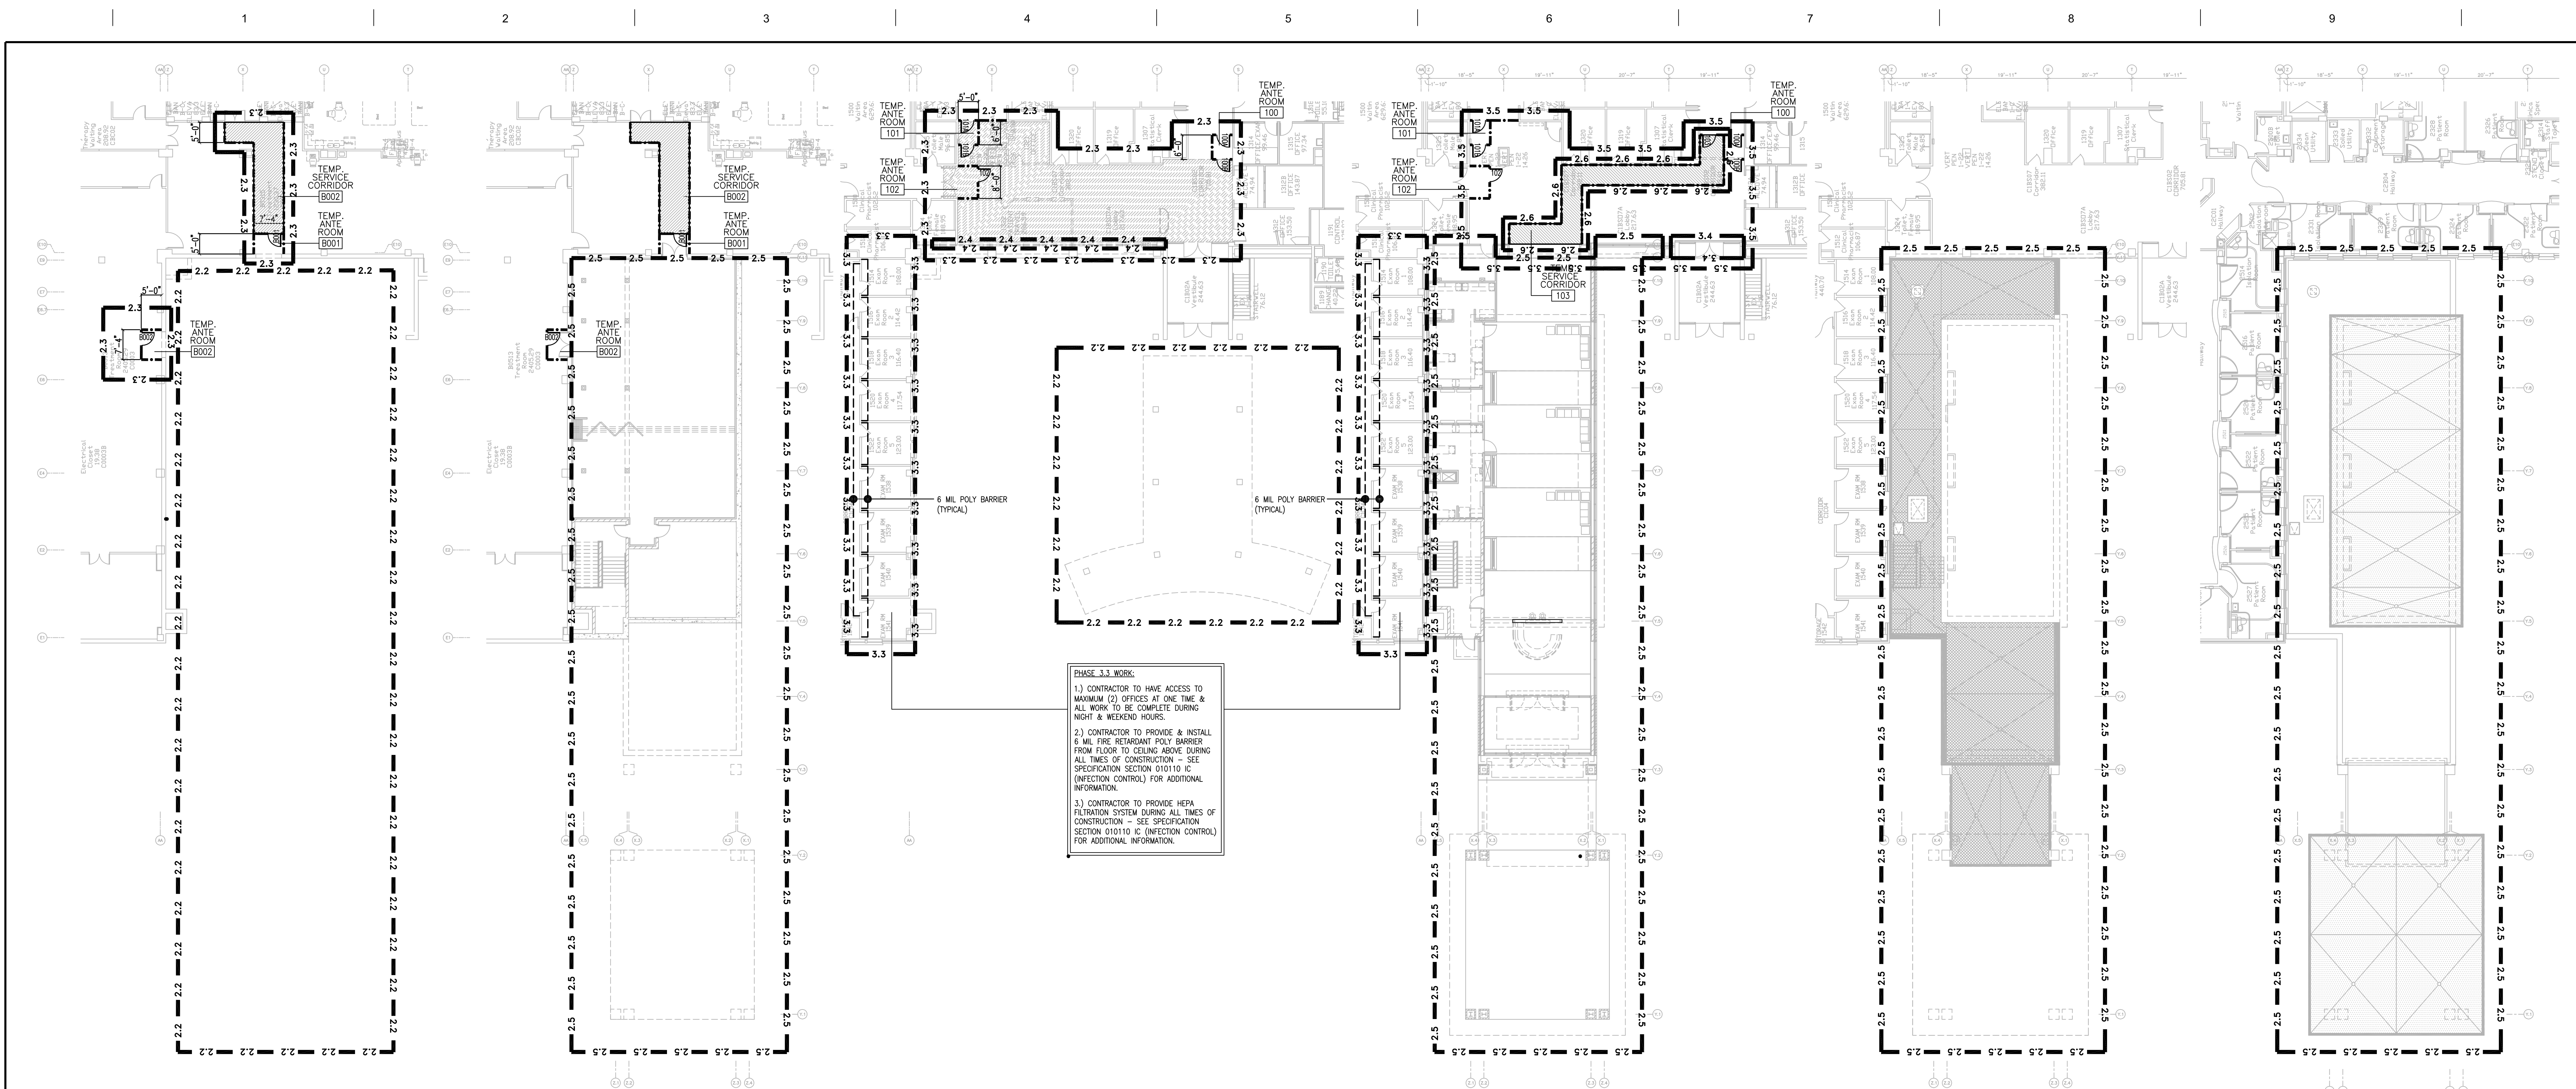

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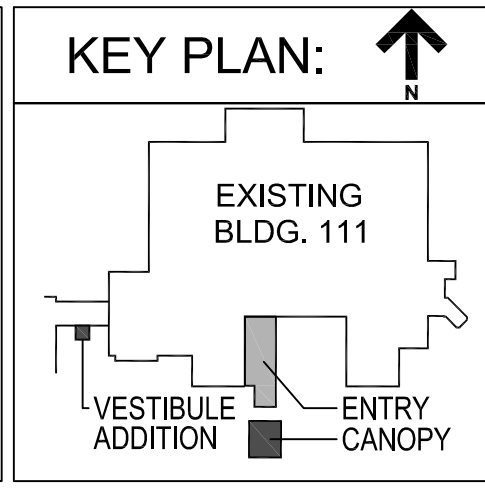
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Dept. of Veterans Affairs  
Medical Center  
5000 W. National Avenue  
Milwaukee, WI



PROJECT LEADER/ARCHITECT:

  
Chequamegon  
Bay Group, Inc.

ASHLAND, WI • MSWALUTKE, WI • MADISON, WI • DULUTH, MN  
(715) 482-0004 (414) 338-4004 (608) 333-8940 (218) 738-4009

[WWW.CHEQBAYGRP.COM](http://WWW.CHEQBAYGRP.COM)

Project Title		
Building 111 - Renovate South Entry		
Location		
Milwaukee, Wisconsin		
Date	Checked By:	Drawn By:
June 23, 2014	MAC	KJS

Office of  
Facilities  
Management

 Department of  
Veterans Affairs
















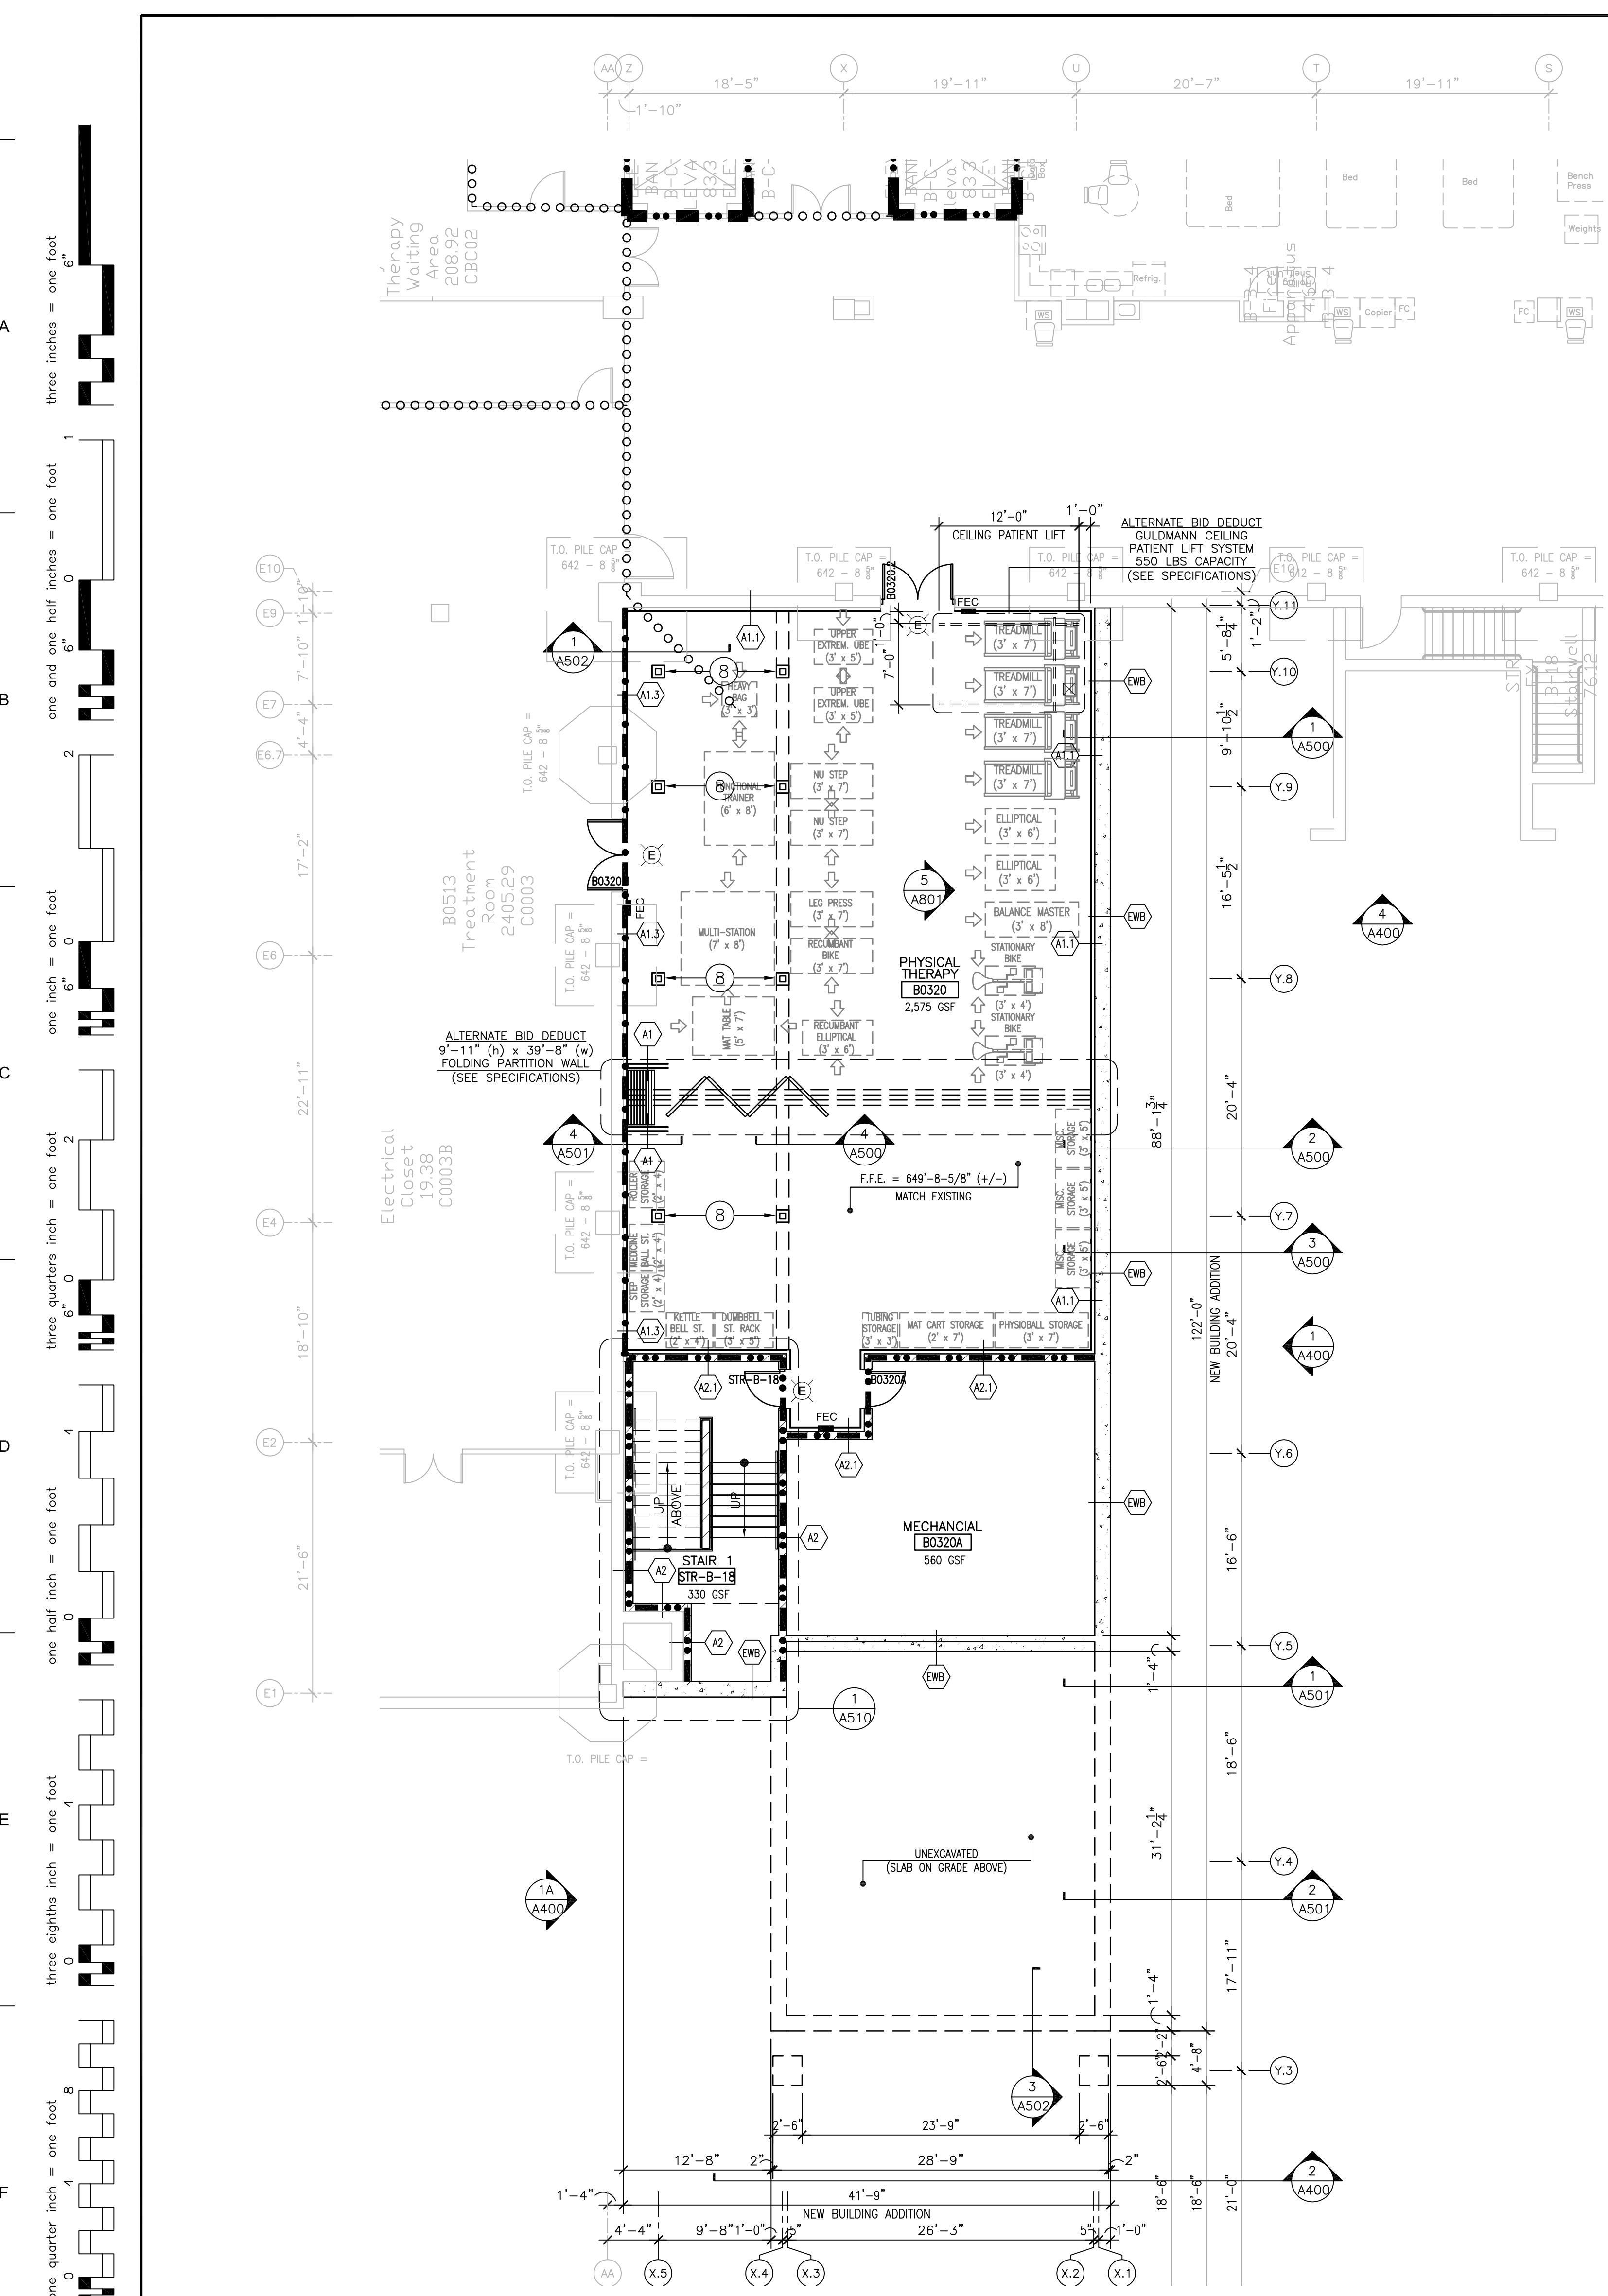

BUILDING 111 - LOWER LEVEL 'ENTRY' PLAN  
SCALE: 1/8" = 1'-0"

#### FLOOR PLAN KEY NOTES:

- 1 NEW CONCRETE STOOP - SEE STRUCTURAL DRAWINGS. (NOT USED ON THIS SHEET)
- 2 NEW CONCRETE WALK - SEE CIVIL DRAWINGS. (NOT USED ON THIS SHEET)
- 3 NEW CONCRETE DRIVE - SEE CIVIL DRAWINGS. (NOT USED ON THIS SHEET)
- 4 RELOCATE EXISTING UTILITIES & FUR OUT EXISTING CONCRETE COLUMN w/ 2" STEEL STUDS & 8" GYPSUM BOARD - FULL HEIGHT. (NOT USED ON THIS SHEET)
- 5 RELOCATE EXISTING ROOM DIRECTORY/SIGN BOARD. CONTRACTOR TO COORDINATE FINAL LOCATION w/ VA PRIOR TO INSTALLATION. (NOT USED ON THIS SHEET)
- 6 INFIL ABANDONED WALL OPENING WHERE WINDOW OPENING HAS BEEN REMOVED. SEE SECTION 4/A501 FOR ADDITIONAL REQUIREMENTS. (NOT USED ON THIS SHEET)
- 7 RELOCATE (2) EXISTING COMPUTER KIOSKS. CONTRACTOR TO COORDINATE FINAL LOCATION w/ VA PRIOR TO INSTALLATION. (NOT USED ON THIS SHEET)
- 8 PROVIDE (2) HOUR RATED SPRAY APPLIED FIREPROOFING (UL DESIGN X795) & FULL HEIGHT GYPSUM BOARD COLUMN ENCLOSURE FOR NEW STEEL COLUMN.
- 9 FURNISHINGS AND/OR EQUIPMENT TO BE PROVIDED BY OWNER.
- 10 30" X 36" ROOF ACCESS HATCH & FIXED LADDER. SEE DETAIL 3/A510. (NOT USED ON THIS SHEET)
- 11 CONTRACTOR TO PROVIDE "NON-STRUCTURAL FLOOR LEVELING @ NEW RECEPTION DESK. FINISH ELEVATION TO BE 661'-8". COORDINATE EXTENT OF FLOOR LEVELING WORK w/ FURNITURE DRAWINGS. (NOT USED ON THIS SHEET)

#### WALL PARTITION TYPES:

- (A1) 3 1/2" STEEL STUDS @ 16" O.C. WITH 3" SOUND ATTENUATION INSULATION & ONE LAYER 5/8" GYPSUM BOARD @ EACH FACE. PROVIDE 1 HR RATED UL #U465 DESIGN WHERE 1 HR WALL CONSTRUCTION IS INDICATED ON PLANS.
- (A1.1) 3 1/2" STEEL STUDS @ 16" O.C. WITH 3" SOUND ATTENUATION INSULATION & ONE LAYER 5/8" GYPSUM BOARD ONE SIDE.
- (A1.2) 3 1/2" STEEL STUDS @ 16" O.C. WITH 3" SOUND ATTENUATION INSULATION. PROVIDE ONE LAYER 5/8" HIGH IMPACT GYPSUM BOARD & 1/8" FIBERGLASS ARMOR PANEL (PUBLIC SIDE) & ONE LAYER 5/8" HIGH IMPACT GYPSUM BOARD (OFFICE SIDE)
- (A1.3) 1" GYPSUM LINER PANELS ON 2 1/2" "C-T" STEEL STUDS @ 16" O.C. WITH ONE LAYER 5/8" GYPSUM BOARD ONE SIDE. PROVIDE 1 HR RATED UL #U417 DESIGN WHERE 1 HR WALL CONSTRUCTION IS INDICATED ON PLANS.
- (A2) 8" FULL-HEIGHT C.M.U. WALL. SEE STRUCTURAL DRAWINGS FOR ADDITIONAL GROUTING & REINFORCING REQUIREMENTS. PROVIDE 2 HR RATED UL #U904 DESIGN WHERE 2 HR WALL CONSTRUCTION IS INDICATED ON PLANS.
- (A2.1) 8" FULL-HEIGHT C.M.U. WALL w/ 2" STEEL STUDS @ 16" O.C. & ONE LAYER OF 5/8" GYPSUM BOARD ONE SIDE. SEE STRUCTURAL DRAWINGS FOR ADDITIONAL GROUTING & REINFORCING REQUIREMENTS. PROVIDE 2 HR RATED UL #U904 DESIGN WHERE 2 HR WALL CONSTRUCTION IS INDICATED ON PLANS.

#### EXTERIOR WALL TYPES:

- (EW) EXTERIOR CONCRETE FOUNDATION WALL: (WALL THICKNESS = AS SHOWN & NOTED) REINFORCED CAST-IN-PLACE CONCRETE FOUNDATION WALL WITH SHEET MEMBRANE WATERPROOFING. TERMINATE ALL MEMBRANE PERIMETER EDGES WITH ALUMINUM COMPRESSION BAR WITH CONTINUOUS SEALANT. PROVIDE 2" RIGID FOUNDATION INSULATION, EXTEND FULL HEIGHT VERTICALLY. SEE STRUCTURAL DRAWINGS FOR ADDITIONAL REINFORCING REQUIREMENTS.
- (EW) TYPICAL EXTERIOR BRICK VENEER WALL: (WALL THICKNESS = AS SHOWN & NOTED) 4" BRICK VENEER WALL CONSISTING OF 4" FACE BRICK, AIR SPACE, 2" RIGID INSULATION, SPRAY APPLIED AIR AND VAPOR BARRIER SYSTEM ON 8" CONCRETE MASONRY UNIT (CMU) WITH ADJUSTABLE (TWO-PIECE) HORIZONTAL MASONRY JOINT REINFORCEMENT. INTERIOR WALL TO BE FURRED OUT WITH 2" STEEL STUDS @ 16" O.C., WITH 5/8" GYPSUM BOARD ONE SIDE. PROVIDE CAVITY DRAINAGE MATERIAL, EMBEDDED FLASHING, CAVITY WEEPS / VENTS @ 24" OC, & MASONRY EXPANSION AND CONTROL JOINTS. COMPARTMENTALIZE CAVITY AND PROVIDE CAVITY WEEPS / VENTS AT TOP AND BOTTOM OF CAVITY TO INDUCE AIR FLOW. NEW BRICK VENEER FINISH MATCH EXISTING BRICK VENEER. SEE SPECIFICATIONS. SEE STRUCTURAL DRAWINGS FOR ADDITIONAL GROUTING & REINFORCING REQUIREMENTS.

#### GENERAL PLAN NOTES:


- CONTRACTOR TO FIELD VERIFY ALL EXISTING CONDITIONS, INCLUDING ALL EXISTING FLOOR-TO-FLOOR HEIGHTS, EXISTING FLOOR/WALL CONSTRUCTION, & ALL EXISTING DIMENSIONS, PRIOR TO THE START OF WORK.
- SEE SPECIFICATIONS FOR MATERIALS SPECIFICATIONS & REQUIREMENTS.
- SEE SHEETS A001 THRU A002 FOR PROJECT PHASING DRAWINGS & NOTES.
- MAINTAIN CONTINUOUS UTILITY SERVICE TO ALL SPACES IN THE BUILDING NOT AFFECTED BY THIS WORK. COORDINATE WITH OWNER ANY DISRUPTION IN SERVICES REQUIRED TO PERFORM WORK OR TO MODIFY EXISTING PIPING, DUCTWORK OR ANY ASSOCIATED EQUIPMENT.
- CONSTRUCT A DUST-PROOF PARTITION TO SEPARATE AREAS OF CONSTRUCTION FROM ADJACENT OCCUPIED AREAS OUTSIDE SCOPE OF CONSTRUCTION.
- ALL NEW WALLS ARE DIMENSIONED FINISHED FACE-OF-WALL TO FINISHED FACE-OF-WALL.
- ALL NEW WALLS TO EXTEND TO UNDERSIDE OF FLOOR OR ROOF STRUCTURE UNLESS NOTED OTHERWISE.
- ALL NEW INTERIOR WALLS TO BE TYPE 'A1' UNLESS NOTED OTHERWISE. SEE PARTITION TYPES.
- ALL EXISTING EXTERIOR WALLS TO BE FURRED OUT w/ TYPE 'A1.1' WALL CONSTRUCTION UNLESS NOTED OTHERWISE. SEE PARTITION TYPES.
- PROVIDE WOOD BLOCKING AS REQUIRED FOR ALL FURNISHINGS & EQUIPMENT.
- SEE SHEET A400 FOR NEW EXTERIOR BUILDING SECTIONS & DETAILS.
- SEE SHEET A500 & A501 FOR NEW EXTERIOR BUILDING SECTIONS & DETAILS.
- SEE SHEET A300 & A301 FOR REFLECTED CEILING PLANS.
- SEE SHEET A810 FOR NEW DOOR SCHEDULE, NEW DOOR & FRAME TYPES, & WINDOW ELEVATIONS.
- PROVIDE CONTINUOUS CAULK JOINT AROUND ALL NEW & EXISTING DOOR & WINDOW OPENINGS, AT ALL NEW & EXISTING MEP PENETRATIONS, & ALL LOCATIONS WHERE DISSIMILAR MATERIALS MEET. TYPICAL OF ALL FLOOR, WALL, & CEILING LOCATIONS.

#### FLOOR PLAN LEGEND:

- FE FIRE EXTINGUISHER
- FEC FIRE EXTINGUISHER CABINET
- E EMERGENCY EXIT LIGHT
- NEW DOOR - SEE DOOR SCHEDULE
- EXISTING DOOR TO REMAIN
- EXISTING DOOR TO BE REMOVED
- NEW WALL/PARTITION - SEE WALL TYPES
- EXISTING WALL TO REMAIN
- EXISTING WALL TO BE REMOVED
- \* NOTE - SEE FLOOR PLAN & PARTITION TYPES FOR ALL WALL WIDTHS & TYPICAL CONSTRUCTION.
- CONSTRUCTION LIMITS
- ONE HOUR FIRE WALL
- TWO HOUR FIRE WALL
- ONE HOUR SMOKE WALL

 <b>Dept. of Veterans Affairs Medical Center 5000 W. National Avenue Milwaukee, WI</b>			<b>KEY PLAN:</b> 	<b>CONSULTANTS:</b> 	<b>PROJECT LEADER/ARCHITECT:</b> 	<b>Drawing Title</b> Building 111 - Lower Level Entry & Canopy Floor Plans	<b>Project Title</b> Building 111 - Renovate South Entry	<b>FINAL CONSTRUCTION DOCUMENTS</b> Project Number 695-12-101SCP Building Number 111 Drawing Number A100		<b>Office of Facilities Management</b> 
Revisions: Date						Approved: Project Director	Location Milwaukee, Wisconsin Date June 23, 2014	Checked By: MAC	Drawn By: KJS	



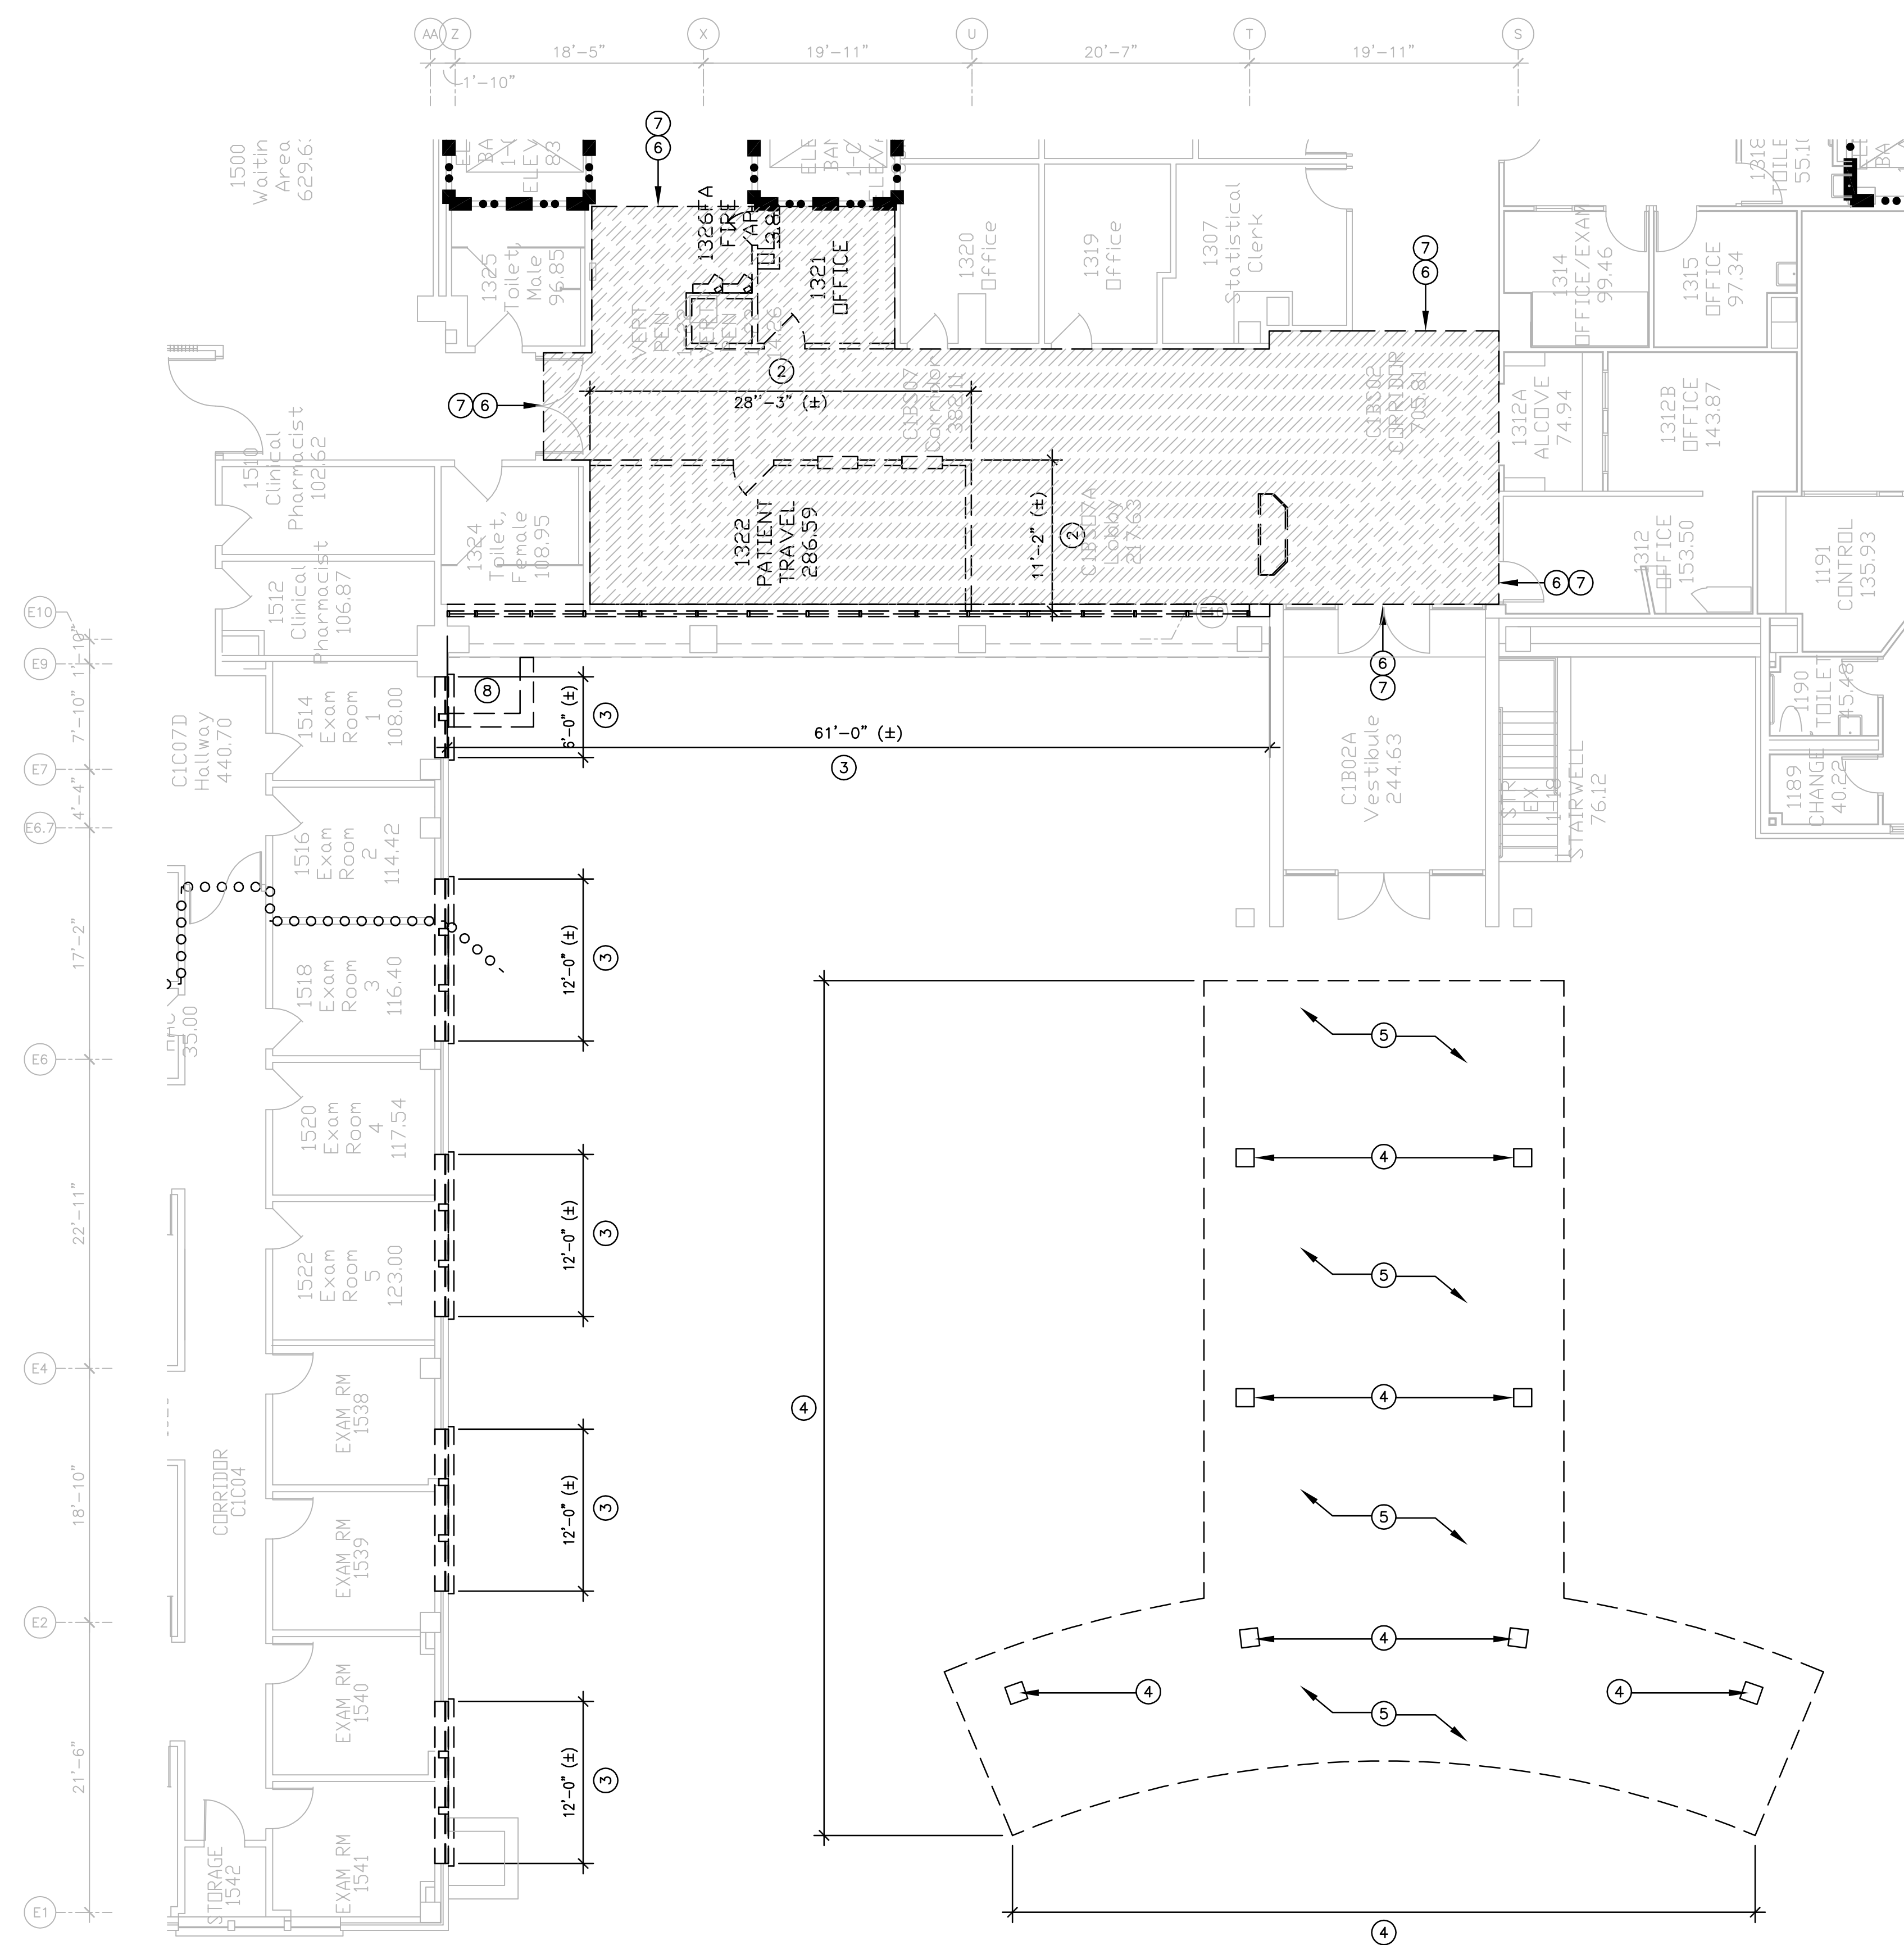

BUILDING 111 - FIRST FLOOR 'ENTRY' DEMOLITION PLAN  
SCALE:  $\frac{1}{8}" = 1'-0"$


DEMOLITION KEY NOTES:

- ① REMOVE FOUNDATION WALL CONSTRUCTION FOR NEW WALL OPENING. COORDINATE EXTENT OF WALL DEMOLITION w/ NEW CONSTRUCTION PLANS. SEE STRUCTURAL DRAWINGS FOR ADDITIONAL STRUCTURAL REQUIREMENTS.  
(NOT USED ON THIS SHEET)
- ② REMOVE EXISTING WALL CONSTRUCTION IN ITS ENTIRETY, INCLUDING ALL DOORS & ASSOCIATED WINDOW OPENINGS FROM FLOOR TO STRUCTURE ABOVE.
- ③ REMOVE EXISTING DOOR/WINDOW OPENING IN ITS ENTIRETY, INCLUDING ALL ASSOCIATED SILLS, HEADS, & FLASHINGS.
- ④ REMOVE EXISTING BUILDING CANOPY IN ITS ENTIRETY INCLUDING ALL ASSOCIATED CONCRETE COLUMNS & FOUNDATION WALL FOOTINGS.
- ⑤ REMOVE EXISTING CONCRETE PAVING. SEE CIVIL DRAWINGS FOR ADDITIONAL REQUIREMENTS.
- ⑥ REMOVE EXISTING CEILING FINISH IN ITS ENTIRETY, INCLUDING ALL ASSOCIATED TRIM, FASTENERS, & FRAMING.
- ⑦ REMOVE EXISTING FLOOR FINISH IN ITS ENTIRETY, INCLUDING NON-STRUCTURAL SELF LEVELING FLOOR COMPOUND, & ALL ASSOCIATED WALL BASE.  
CONTRACTOR TO PROVIDE NEW 'NON-STRUCTURAL' FLOOR LEVELING COMPOUND WHERE EXISTING FLOORING HAS BEEN REMOVED, IN PREPARATION FOR NEW FLOOR FINISH. NEW FINISHED FLOOR ELEVATION TO MATCH EXISTING.
- ⑧ REMOVE EXISTING BUILDING AREA WELL IN ITS ENTIRETY INCLUDING ALL ASSOCIATED CONCRETE COLUMNS & FOUNDATION WALL FOOTINGS.

DEMOLITION PLAN NOTES:

- SEE SHEETS A001 THRU A002 FOR PROJECT PHASING DRAWINGS & NOTES.
- ALL DEMOLITION WORK TO BE BY GENERAL CONTRACTOR UNLESS NOTED OTHERWISE.
- GENERAL CONTRACTOR RESPONSIBLE FOR THE COORDINATION OF ALL DEMOLITION W/ NEW CONSTRUCTION WORK.
- ALL EQUIPMENT & FURNISHINGS TO BE DISCONNECTED AND REMOVED BY CONTRACTOR. VA TO BE NOTIFIED WHEN EQUIPMENT & FURNISHINGS ARE AVAILABLE AND BE GIVEN THE OPTION TO TAKE POSSESSION OF ALL EQUIPMENT & FURNISHING.
- CONTRACTOR TO DISPOSE & REMOVE ALL EQUIPMENT & FURNISHINGS FROM PROJECT SITE THAT THE VA DOES NOT CARE TO RETAIN.
- VERIFY ALL DIMENSIONS & EXISTING CONDITIONS AT JOB SITE PRIOR TO THE START OF DEMOLITION WORK. CONTRACTOR IS RESPONSIBLE FOR THE DEMOLITION & REMOVAL OF ALL ITEMS AS REQUIRED TO MEET THE REQUIREMENTS OF THE NEW CONSTRUCTION DRAWINGS.
- UNLESS NOTED OTHERWISE, ALL DASHED ITEMS ARE TO BE REMOVED.
- REFER TO MEP DRAWINGS FOR ADDITIONAL DEMOLITION ITEMS & NOTES. COORDINATE DEMOLITION WORK w/ PLUMBING, HVAC & ELECTRICAL REQUIREMENTS.
- REFER TO CIVIL DRAWINGS FOR ADDITIONAL SITE DEMOLITION ITEMS & NOTES.
- MAINTAIN CONTINUOUS UTILITY SERVICE TO ALL SPACES IN THE BUILDING NOT AFFECTED BY THIS WORK. COORDINATE WITH OWNER ANY DISRUPTION IN SERVICES REQUIRED TO PERFORM WORK OR TO MODIFY EXISTING PIPING, DUCTWORK OR ANY ASSOCIATED EQUIPMENT.
- CONSTRUCT A DUST-PROOF PARTITION TO SEPARATE AREAS OF CONSTRUCTION FROM ADJACENT OCCUPIED AREAS OUTSIDE SCOPE OF CONSTRUCTION.

FLOOR PLAN LEGEND:

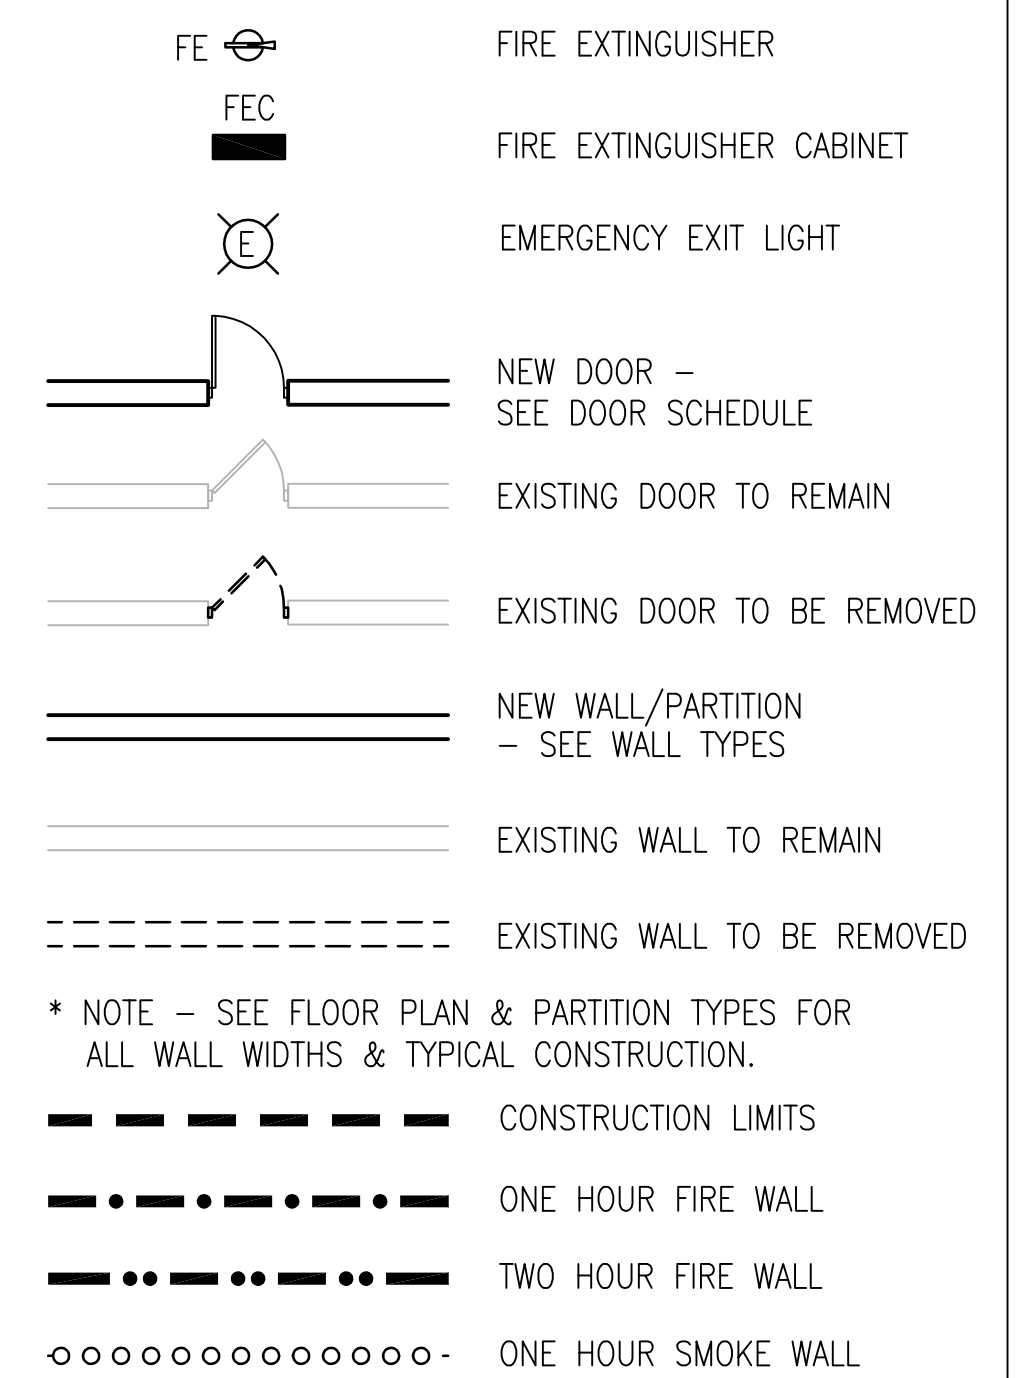



Revisions:
Date



Dept. of Veterans Affairs  
Medical Center  
5000 W. National Avenue  
Milwaukee, WI



KEY PLAN:

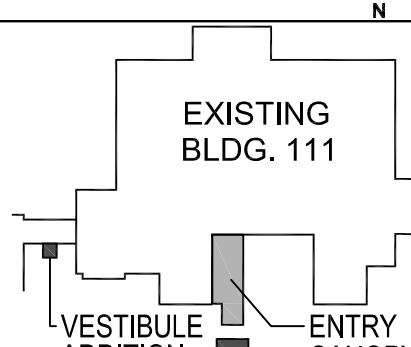

CONSULTANTS:



PROJECT LEADER/ARCHITECT:



Drawing Title  
**Building 111 -  
First Floor Entry  
Demolition Plan**

Approved: Project Director

Project Title	Building 111 - Renovate South Entry
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Location	Milwaukee, Wisconsin
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Checked By:  
**MAC**

Drawn By:  
KJS


FINAL CONSTRUCTION DOCUMENTS

Project Number	695-12-101SCP
Building Number	111
Drawing Number	


Office of  
Facilities  
Management





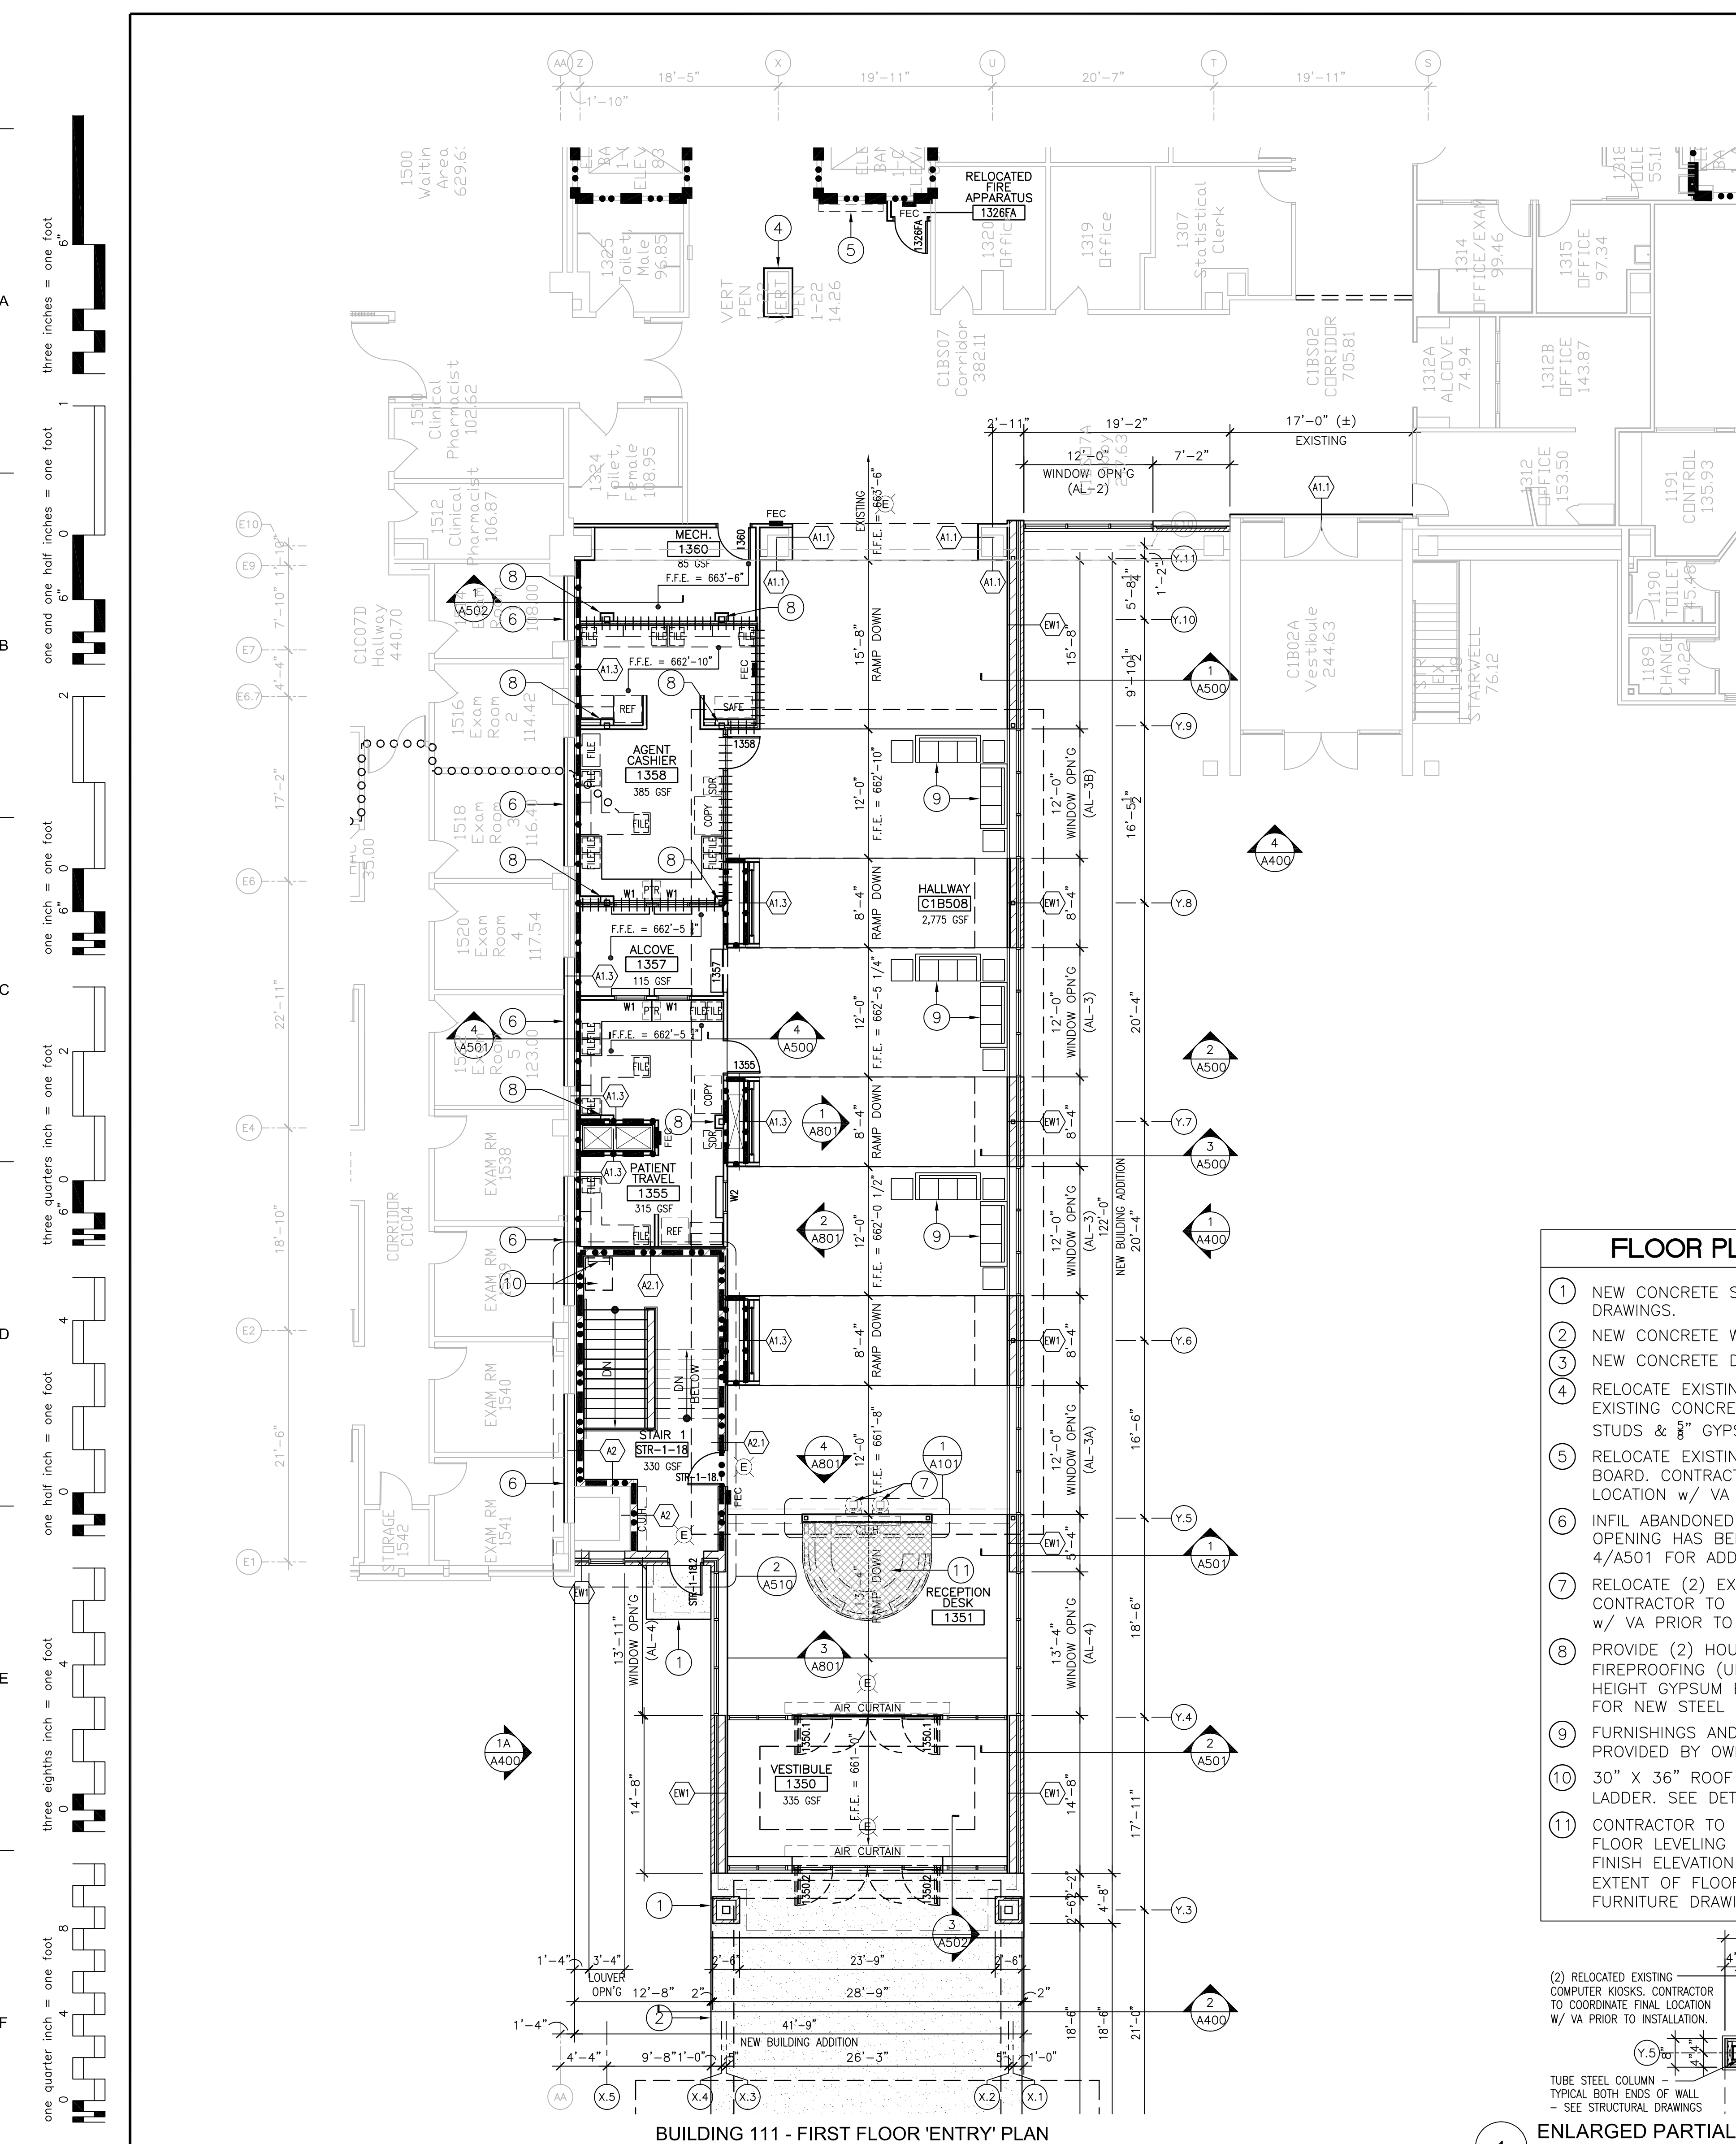

BUILDING 111 - FIRST FLOOR 'ENTRY' PLAN  
SCALE: 1/8" = 1'-0"

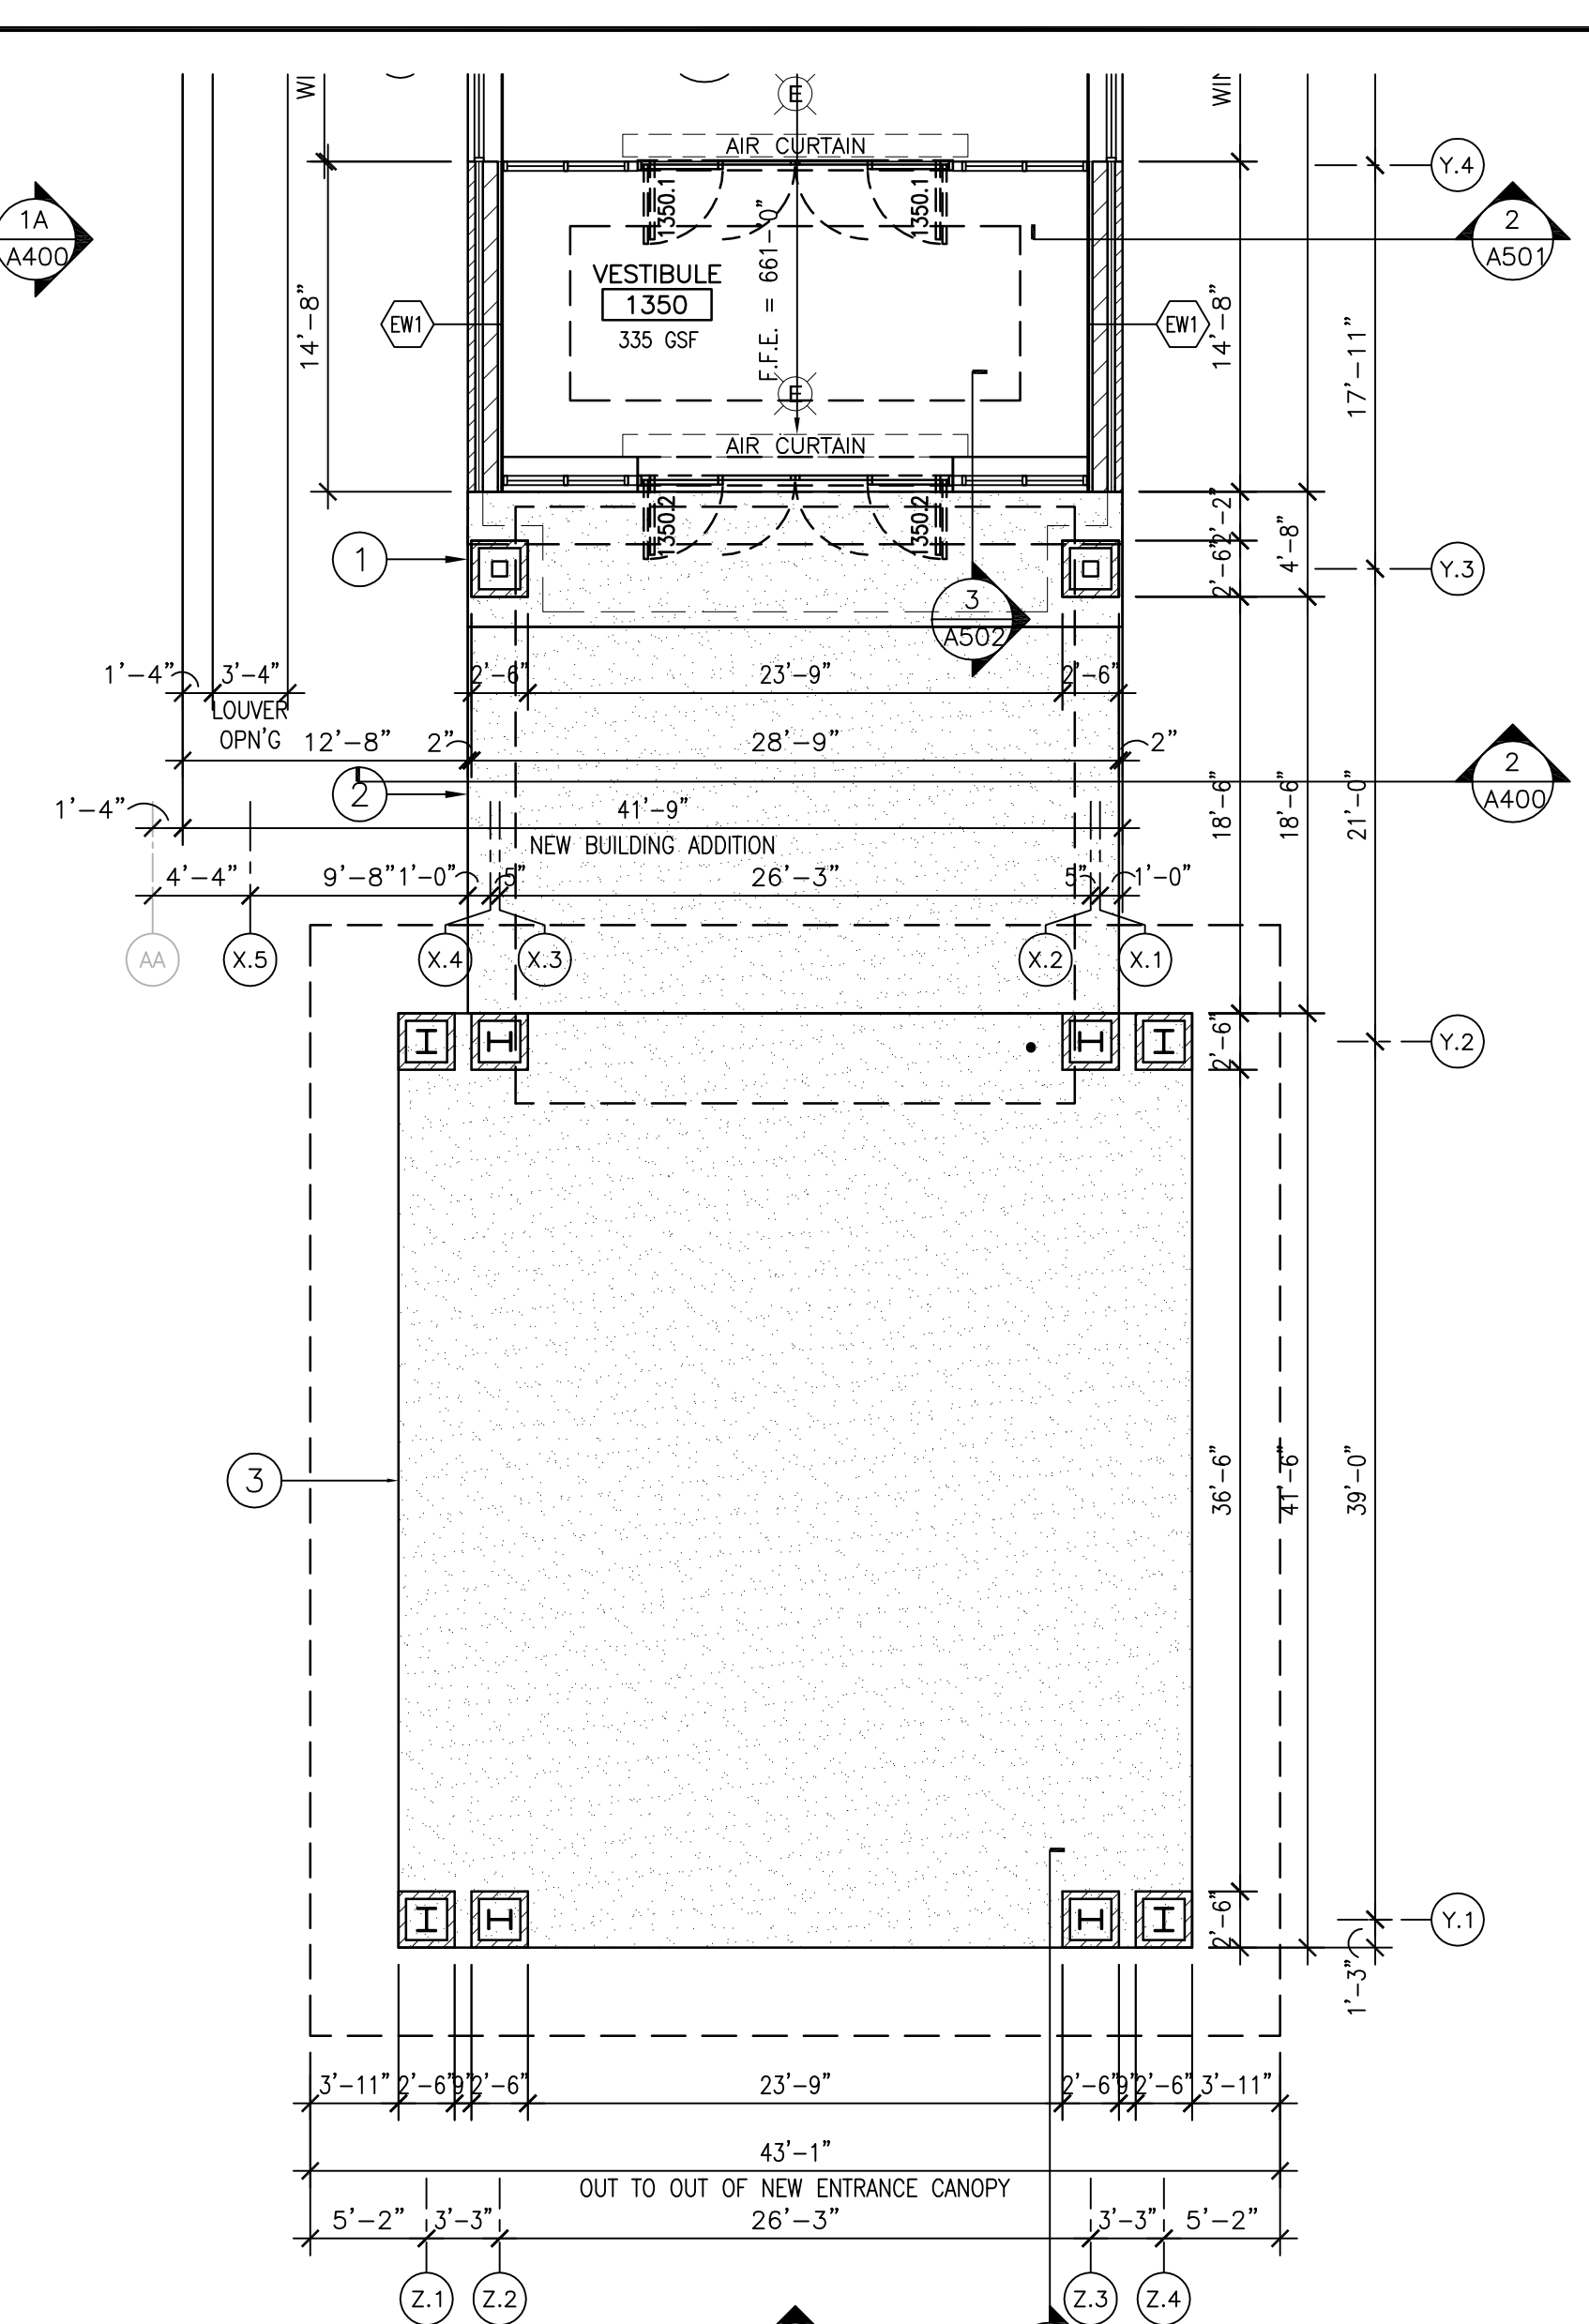

BUILDING 111 - FIRST FLOOR 'CANOPY' PLAN  
SCALE: 1/8" = 1'-0"

FLOOR PLAN KEY NOTES:

- 1 NEW CONCRETE STOOP - SEE STRUCTURAL DRAWINGS.
- 2 NEW CONCRETE WALK - SEE CIVIL DRAWINGS.
- 3 NEW CONCRETE DRIVE - SEE CIVIL DRAWINGS.
- 4 RELOCATE EXISTING UTILITIES & FUR OUT EXISTING CONCRETE COLUMN w/ 2" STEEL STUDS & 8" GYPSUM BOARD - FULL HEIGHT.
- 5 RELOCATE EXISTING ROOM DIRECTORY/SIGN BOARD. CONTRACTOR TO COORDINATE FINAL LOCATION w/ VA PRIOR TO INSTALLATION.
- 6 INFIL ABANDONED WALL OPENING WHERE WINDOW OPENING HAS BEEN REMOVED. SEE SECTION 4/A501 FOR ADDITIONAL REQUIREMENTS.
- 7 RELOCATE (2) EXISTING COMPUTER KIOSKS. CONTRACTOR TO COORDINATE FINAL LOCATION w/ VA PRIOR TO INSTALLATION.
- 8 PROVIDE (2) HOUR RATED SPRAY APPLIED FIREPROOFING (UL DESIGN X795) & FULL HEIGHT GYPSUM BOARD COLUMN ENCLOSURE FOR NEW STEEL COLUMN.
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- 11 CONTRACTOR TO PROVIDE 'NON-STRUCTURAL FLOOR LEVELING @ NEW RECEPTION DESK. FINISH ELEVATION TO BE 661'-8". COORDINATE EXTENT OF FLOOR LEVELING WORK w/ FURNITURE DRAWINGS.

WALL PARTITION TYPES:


- 1 3 1/2" STEEL STUDS @ 16" OC WITH 3" SOUND ATTENUATION INSULATION & ONE LAYER 5/8" GYPSUM BOARD @ EACH FACE. PROVIDE 1 HR RATED UL #U465 DESIGN WHERE 1 HR WALL CONSTRUCTION IS INDICATED ON PLANS.
- 2 3 1/2" STEEL STUDS @ 16" OC WITH 3" SOUND ATTENUATION INSULATION & ONE LAYER 5/8" GYPSUM BOARD ONE SIDE.
- 3 3 1/2" STEEL STUDS @ 16" OC WITH 3" SOUND ATTENUATION INSULATION. PROVIDE ONE LAYER 5/8" HIGH IMPACT GYPSUM BOARD & 1/2" FIBERGLASS ARMOR PANEL (PUBLIC SIDE) & ONE LAYER 5/8" HIGH IMPACT GYPSUM BOARD (OFFICE SIDE)
- 4 1" GYPSUM LINER PANELS ON 2 1/2" "C-T" STEEL STUDS @ 16" O.C. WITH ONE LAYER 5/8" GYPSUM BOARD ONE SIDE. PROVIDE 1 HR RATED UL #U417 DESIGN WHERE 1 HR WALL CONSTRUCTION IS INDICATED ON PLANS.
- 5 8" FULL-HEIGHT C.M.U. WALL. SEE STRUCTURAL DRAWINGS FOR ADDITIONAL GROUTING & REINFORCING REQUIREMENTS. PROVIDE 2 HR RATED UL #U904 DESIGN WHERE 2 HR WALL CONSTRUCTION IS INDICATED ON PLANS.
- 6 8" FULL-HEIGHT C.M.U. WALL w/ 2" STEEL STUDS @ 16" O.C. & ONE LAYER OF 5/8" GYPSUM BOARD ONE SIDE. SEE STRUCTURAL DRAWINGS FOR ADDITIONAL GROUTING & REINFORCING REQUIREMENTS. PROVIDE 2 HR RATED UL #U904 DESIGN WHERE 2 HR WALL CONSTRUCTION IS INDICATED ON PLANS.

EXTERIOR WALL TYPES:

- 1 EXTERIOR CONCRETE FOUNDATION WALL: (WALL THICKNESS = AS SHOWN & NOTED) REINFORCED CAST-IN-PLACE CONCRETE FOUNDATION WALL WITH SHEET MEMBRANE WATERPROOFING. TERMINATE ALL MEMBRANE PERIMETER EDGES WITH ALUMINUM COMPRESSION BAR WITH CONTINUOUS SEALANT. PROVIDE 2" RIGID FOUNDATION INSULATION, EXTEND FULL HEIGHT VERTICALLY. SEE STRUCTURAL DRAWINGS FOR ADDITIONAL REINFORCING REQUIREMENTS.
- 2 TYPICAL EXTERIOR BRICK VENEER WALL: (WALL THICKNESS = AS SHOWN & NOTED) 4" BRICK VENEER WALL CONSISTING OF 4" FACE BRICK, AIR SPACE, 2" RIGID INSULATION, SPRAY APPLIED AIR AND VAPOR BARRIER SYSTEM ON 8" CONCRETE MASONRY UNIT (CMU) WITH ADJUSTABLE (TWO-PIECE) HORIZONTAL MASONRY JOINT REINFORCEMENT. INTERIOR WALL TO BE FURRED OUT WITH 2" STEEL STUDS @ 16" O.C., WITH 5/8" GYPSUM BOARD ONE SIDE. PROVIDE CAVITY DRAINAGE MATERIAL, EMBEDDED FLASHING, CAVITY WEEPS / VENTS @ 24" OC, & MASONRY EXPANSION AND CONTROL JOINTS. COMPARTMENTALIZE CAVITY AND PROVIDE CAVITY WEEPS / VENTS AT TOP AND BOTTOM OF CAVITY TO INDUCE AIR FLOW. NEW BRICK VENEER FINISH MATCH EXISTING BRICK VENEER. SEE SPECIFICATIONS. SEE STRUCTURAL DRAWINGS FOR ADDITIONAL GROUTING & REINFORCING REQUIREMENTS.

FLOOR PLAN LEGEND:

- FE FIRE EXTINGUISHER  
FEC FIRE EXTINGUISHER CABINET  
E EMERGENCY EXIT LIGHT  
NEW DOOR - SEE DOOR SCHEDULE  
EXISTING DOOR TO REMAIN  
EXISTING DOOR TO BE REMOVED  
NEW WALL/PARTITION - SEE WALL TYPES  
EXISTING WALL TO REMAIN  
EXISTING WALL TO BE REMOVED  
NOTE - SEE FLOOR PLAN & PARTITION TYPES FOR ALL WALL WIDTHS & TYPICAL CONSTRUCTION.  
CONSTRUCTION LIMITS  
ONE HOUR FIRE WALL  
TWO HOUR FIRE WALL  
ONE HOUR SMOKE WALL  
SECURE WALL PARTITION (SEE PARTITION TYPE A1.2)

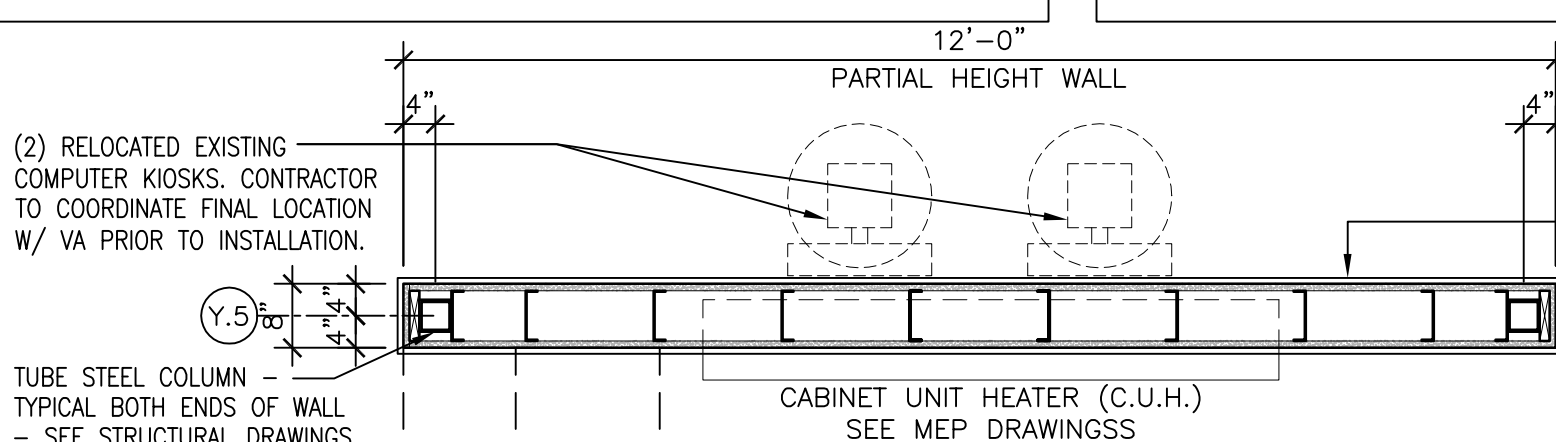


1 ENLARGED PARTIAL HEIGHT WALL @ RECEPTION  
SCALE: 1 1/2" = 1'-0"

Revisions:	Date



Dept. of Veterans Affairs  
Medical Center  
5000 W. National Avenue  
Milwaukee, WI

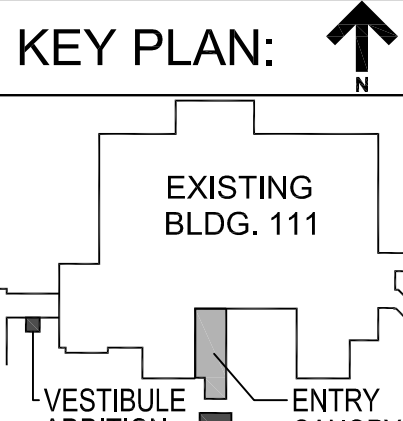


Drawing Title Building 111 - First Floor Entry & Canopy Floor Plans
Approved: Project Director


Project Title Building 111 - Renovate South Entry
Location Milwaukee, Wisconsin
Date June 23, 2014
Checked By: MAC
Drawn By: KJS

FINAL CONSTRUCTION DOCUMENTS	
Project Number 695-12-101SCP	Office of Facilities Management
Building Number 111	
Drawing Number A101	Department of Veterans Affairs



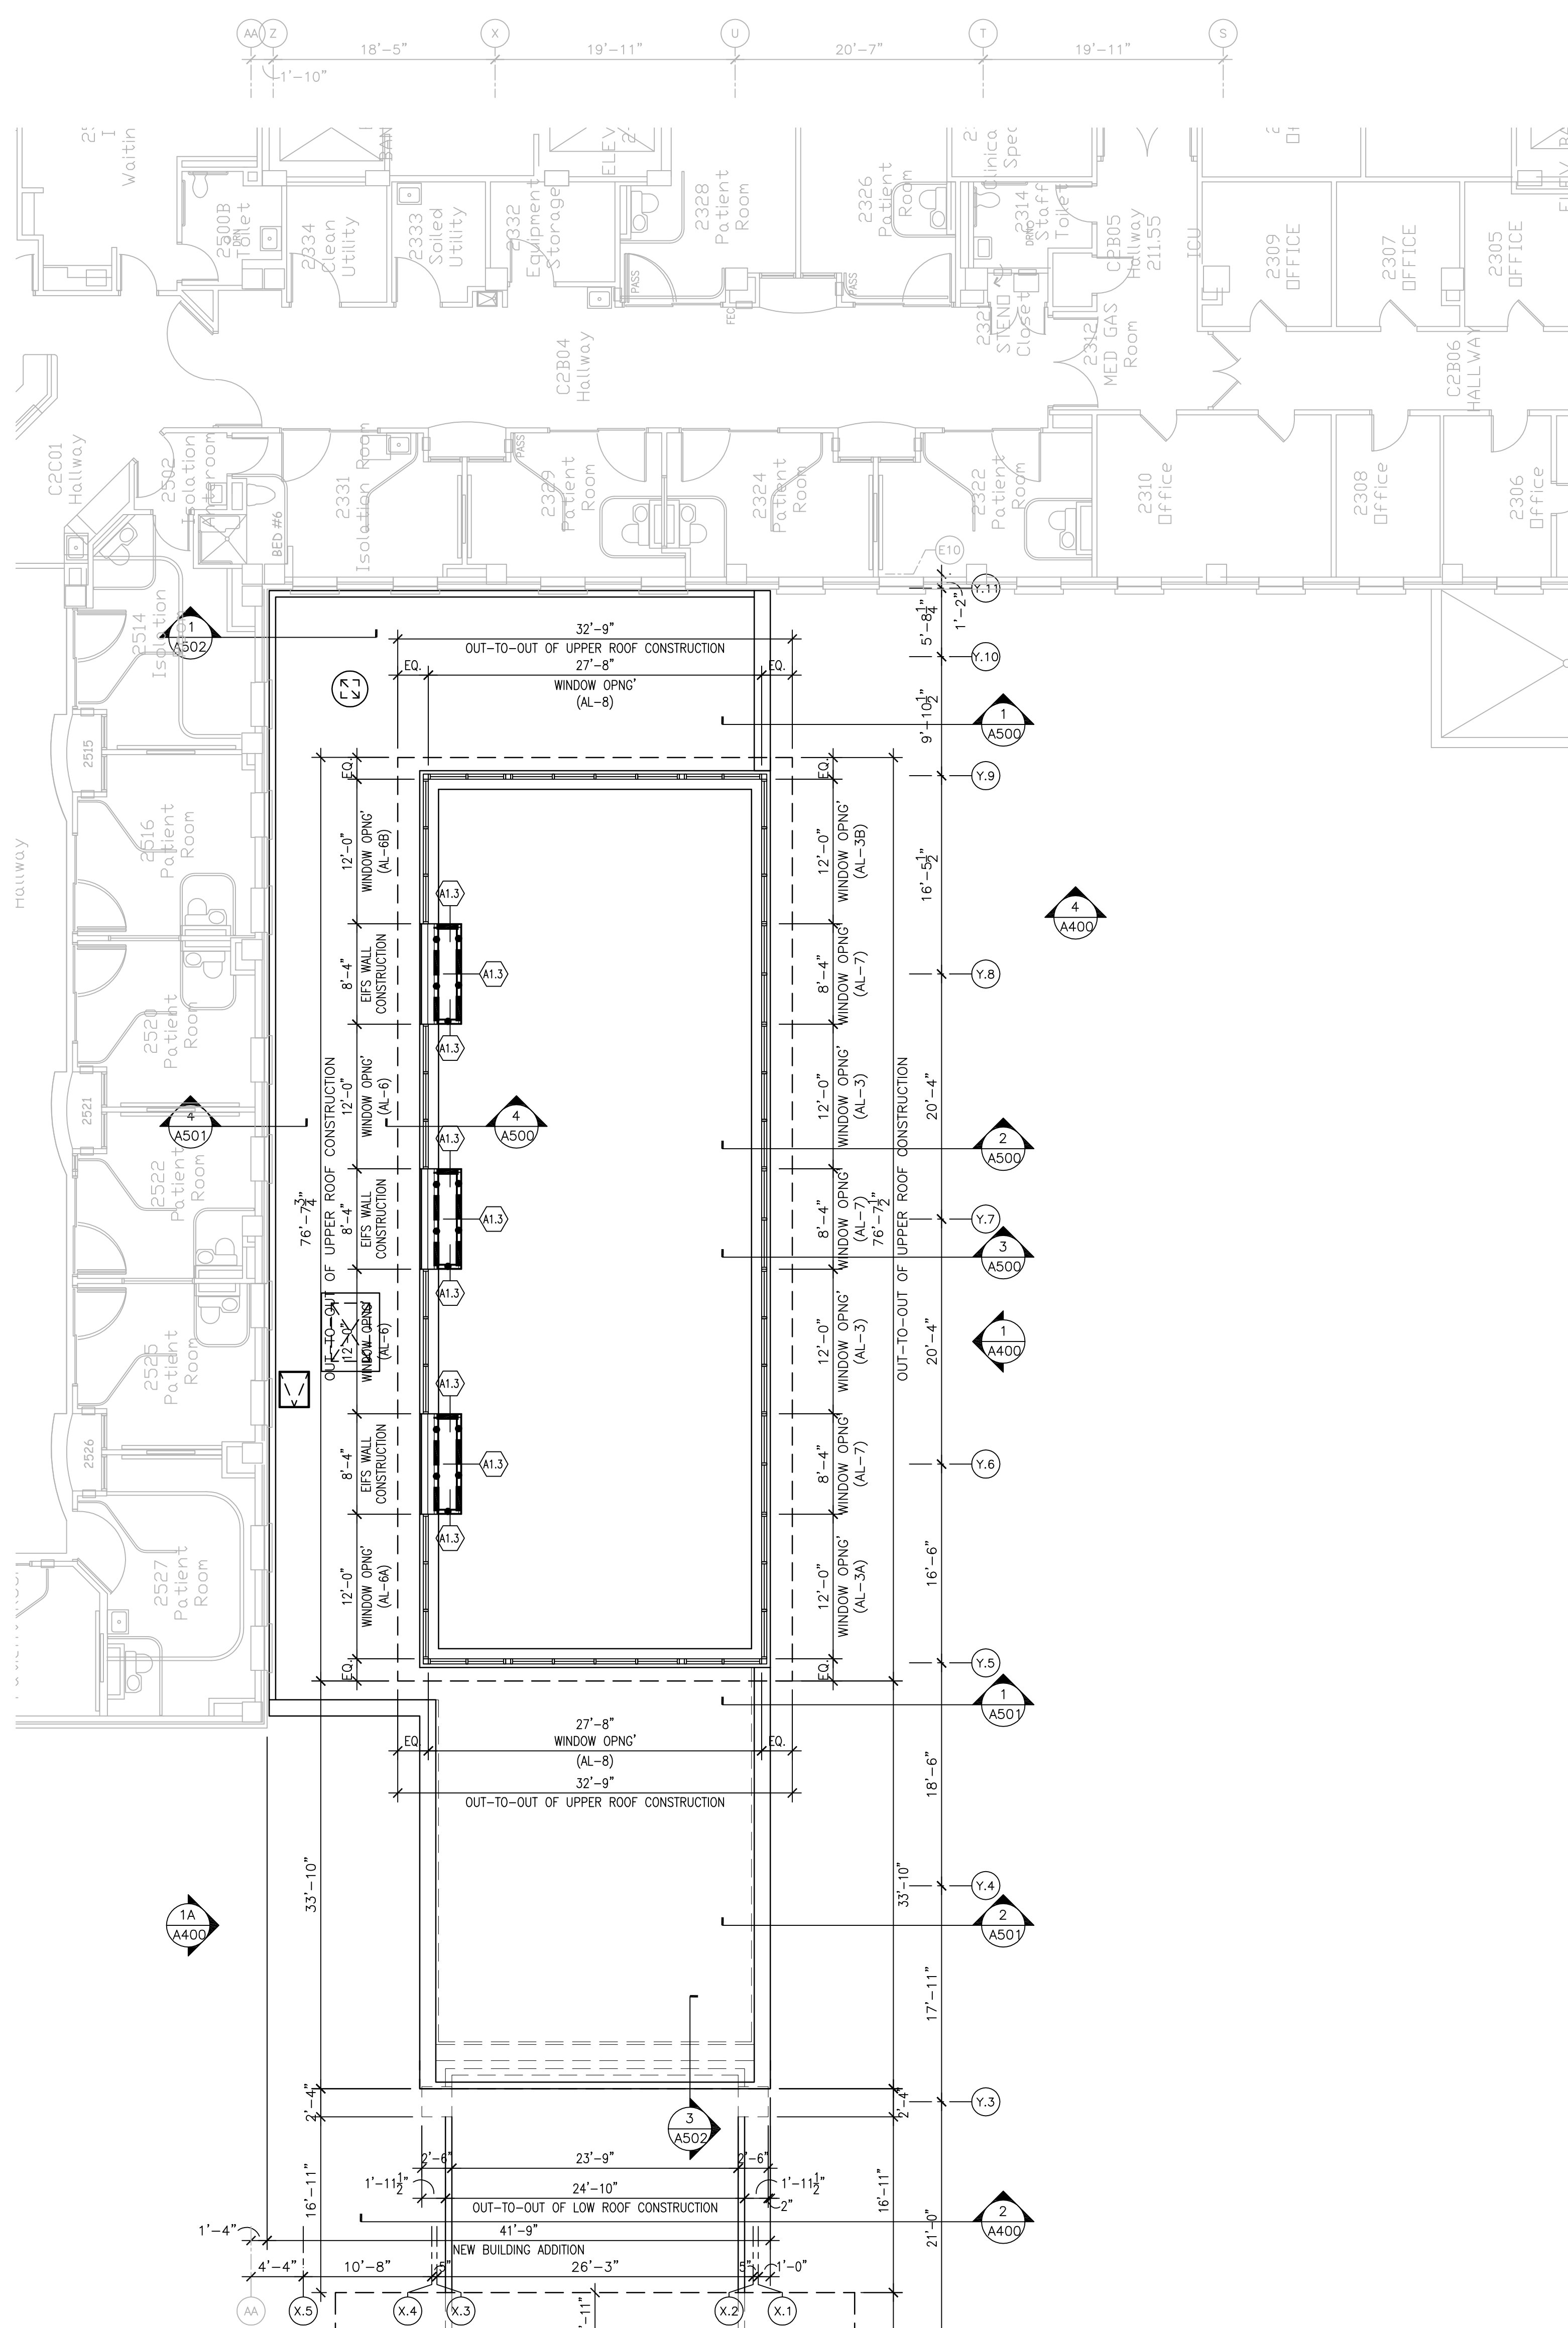

BUILDING 111 - FIRST FLOOR 'ENTRY' CLEARSTORY PLAN  
SCALE:  $\frac{1}{8}" = 1'-0"$

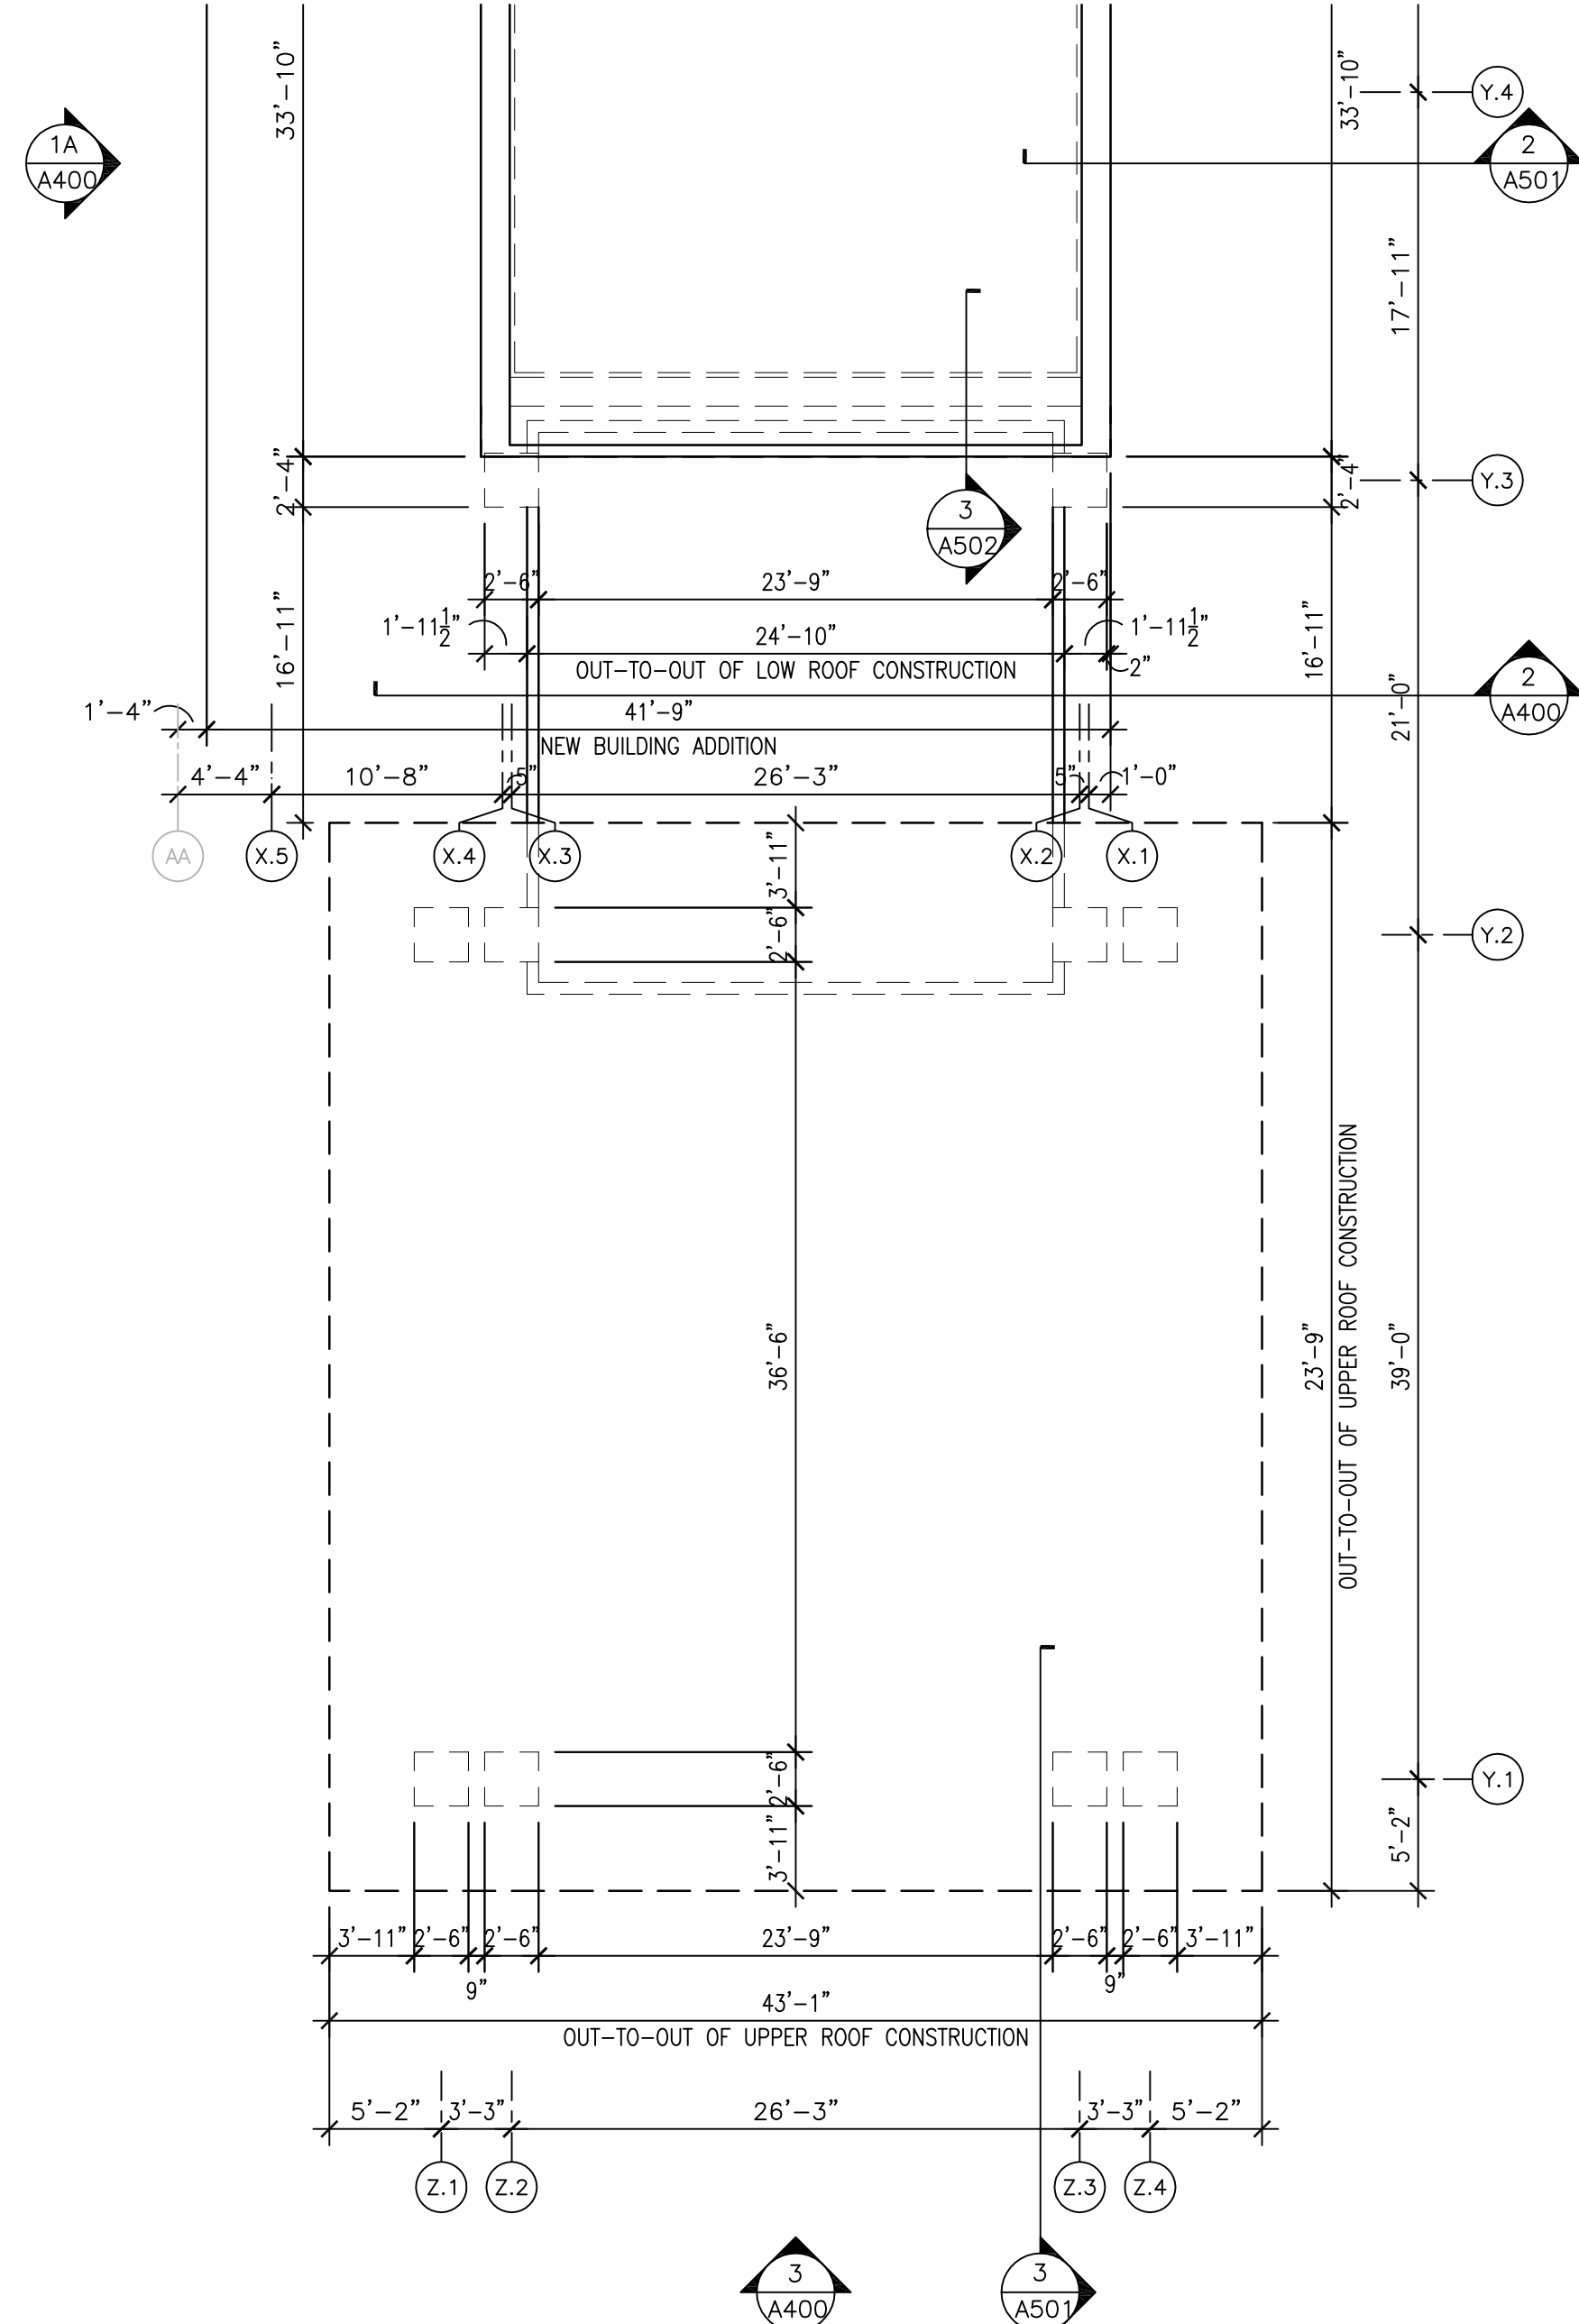




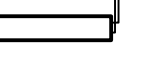



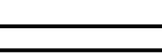





BUILDING 111 - FIRST FLOOR 'CANOPY' CLEARSTORY PLAN  
SCALE: 1/8" = 1'-0"

- ## GENERAL PLAN NOTES:
- CONTRACTOR TO FIELD VERIFY ALL EXISTING CONDITIONS, INCLUDING ALL EXISTING FLOOR-TO-FLOOR HEIGHTS, EXISTING FLOOR/WALL CONSTRUCTION, & ALL EXISTING DIMENSIONS, PRIOR TO THE START OF WORK.
  - SEE SPECIFICATIONS FOR MATERIALS SPECIFICATIONS & REQUIREMENTS.
  - SEE SHEETS A001 THRU A002 FOR PROJECT PHASING DRAWINGS & NOTES.
  - MAINTAIN CONTINUOUS UTILITY SERVICE TO ALL SPACES IN THE BUILDING NOT AFFECTED BY THIS WORK. COORDINATE WITH OWNER ANY DISRUPTION IN SERVICES REQUIRED TO PERFORM WORK OR TO MODIFY EXISTING PIPING, DUCTWORK OR ANY ASSOCIATED EQUIPMENT.
  - CONSTRUCT A DUST-PROOF PARTITION TO SEPARATE AREAS OF CONSTRUCTION FROM ADJACENT OCCUPIED AREAS OUTSIDE SCOPE OF CONSTRUCTION.
  - ALL NEW WALLS ARE DIMENSIONED FINISHED FACE-OF-WALL TO FINISHED FACE-OF-WALL.
  - ALL NEW WALLS TO EXTEND TO UNDERSIDE OF FLOOR OR ROOF STRUCTURE UNLESS NOTED OTHERWISE.
  - ALL NEW INTERIOR WALLS TO BE TYPE 'A1' UNLESS NOTED OTHERWISE. SEE PARTITION TYPES.
  - ALL EXISTING EXTERIOR WALLS TO BE FURRED OUT w/ TYPE 'A1.1' WALL CONSTRUCTION UNLESS NOTED OTHERWISE. SEE PARTITION TYPES.
  - PROVIDE WOOD BLOCKING AS REQUIRED FOR ALL FURNISHINGS & EQUIPMENT.
  - SEE SHEET A400 FOR NEW EXTERIOR ELEVATIONS & DETAILS.
  - SEE SHEET A500 & A501 FOR NEW EXTERIOR BUILDING SECTIONS & DETAILS.
  - SEE SHEET A300 & A301 FOR REFLECTED CEILING PLANS.
  - SEE SHEET A810 FOR NEW DOOR SCHEDULE, NEW DOOR & FRAME TYPES, & WINDOW ELEVATIONS.
  - PROVIDE CONTINUOUS CAULK JOINT AROUND ALL NEW & EXISTING DOOR & WINDOW OPENINGS, AT ALL NEW & EXISTING MEP PENETRATIONS, & ALL LOCATIONS WHERE DISSIMILAR MATERIALS MEET. TYPICAL OF ALL FLOOR, WALL, & CEILING LOCATIONS.

## WALL PARTITION TYPES:

- A1** 3 3/8" STEEL STUDS @ 16" OC WITH 3" SOUND ATTENUATION INSULATION & ONE LAYER 5/8" GYPSUM BOARD @ EACH FACE. PROVIDE 1 HR RATED UL#465 DESIGN WHERE 1 HR WALL CONSTRUCTION IS INDICATED ON PLANS.
- A1.3** 3 3/8" STEEL STUDS @ 16" OC WITH 3" SOUND ATTENUATION INSULATION & ONE LAYER 5/8" GYPSUM BOARD ONE SIDE.
- A1.2** 3 3/8" STEEL STUDS @ 16" OC WITH 3" SOUND ATTENUATION INSULATION. PROVIDE ONE LAYER 5/8" HIGH IMPACT GYPSUM BOARD & 3/8" FIBERGLASS ARMOR PANEL (PUBLIC SIDE) AND ONE LAYER 3/8" HIGH IMPACT GYPSUM BOARD (OFFICE SIDE)
- A1.3** 1" GYPSUM LINER PANELS ON 2 1/2" 'C'-1" STEEL STUDS @ 16" OC WITH ONE LAYER 5/8" GYPSUM BOARD ONE SIDE. PROVIDE 1 HR RATED UL#417 DESIGN WHERE 1 HR WALL CONSTRUCTION IS INDICATED ON PLANS.
- A2** 8" FULL-HEIGHT C.M.U. WALL. SEE STRUCTURAL DRAWINGS FOR ADDITIONAL GROUTING & REINFORCING REQUIREMENTS. PROVIDE 2 HR RATED UL#904 DESIGN WHERE 2 HR WALL CONSTRUCTION IS INDICATED ON PLANS.
- A2.3** 8" FULL-HEIGHT C.M.U. WALL w/ 2" STEEL STUDS @ 16" OC & ONE LAYER 5/8" GYPSUM BOARD ONE SIDE. SEE STRUCTURAL DRAWINGS FOR ADDITIONAL GROUTING & REINFORCING REQUIREMENTS. PROVIDE 2 HR RATED UL#904 DESIGN WHERE 2 HR WALL CONSTRUCTION IS INDICATED ON PLANS.

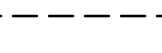
FLOOR PLAN LEGEND:

- |   |  |
|---|--|
|  | FIRE EXTINGUISHER                      |
|  | FIRE EXTINGUISHER CABINET              |
|  | EMERGENCY EXIT LIGHT                   |
|  | NEW DOOR –<br>SEE DOOR SCHEDULE        |
|  | EXISTING DOOR TO REMAIN                |
|  | EXISTING DOOR TO BE REMOVED            |
|  | NEW WALL/PARTITION<br>– SEE WALL TYPES |
|  | EXISTING WALL TO REMAIN                |
|  | EXISTING WALL TO BE REMOVED            |
| * NOTE – SEE FLOOR PLAN & PARTITION TYPES FOR ALL WALL WIDTHS & TYPICAL CONSTRUCTION. |  |
|  | CONSTRUCTION LIMITS                    |
|  | ONE HOUR FIRE WALL                     |
|  | TWO HOUR FIRE WALL                     |
|  | ONE HOUR SMOKE WALL                    |



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
Dept. of Veterans Affairs  
Medical Center  
5000 W. National Avenue  
Milwaukee, WI



**KEY PLAN:** 

**EXISTING BLDG. 111**

**VESTIBULE ADDITION**  **ENTRY CANOPY** 



The key plan shows a large, irregularly shaped building footprint labeled 'EXISTING BLDG. 111'. A grey rectangular area, labeled 'VESTIBULE ADDITION', is attached to the bottom center of the main building. A smaller black rectangular area, labeled 'ENTRY CANOPY', is located just below the vestibule addition. A north arrow is located in the top right corner of the key plan area.

CONSULTANTS:

 RING & DUCHATEAU	 R.A. Smith National
---	--

**PROJECT LEADER/ARCHITECT:**

  
**Chequamegon**  
 Bay Group, Inc.

ASHLAND, WI • MELWAUKEE, WI • MADISON, WI • DULUTH, MN  
 (715) 483-8204 • (914) 338-4054 • (608) 233-8442 • (218) 728-0093

[WWW.CHEQUAMOGON.COM](http://WWW.CHEQUAMOGON.COM)

Drawing Title	Building 111 - First Floor Entry & Canopy Clearstory Plan
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Approved: Project Director

Project Title	Building 111 - Renovate South Entry
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Location	Milwaukee, Wisconsin
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Checked By: <b>MAC</b>	Drawn By: <b>KJS</b>
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FINAL CONSTRUCTION DOCUMENTS

Project Number	695-12-101SCF
Building Number	111

Drawing Number  
A102

Office of  
Facilities  
Management

















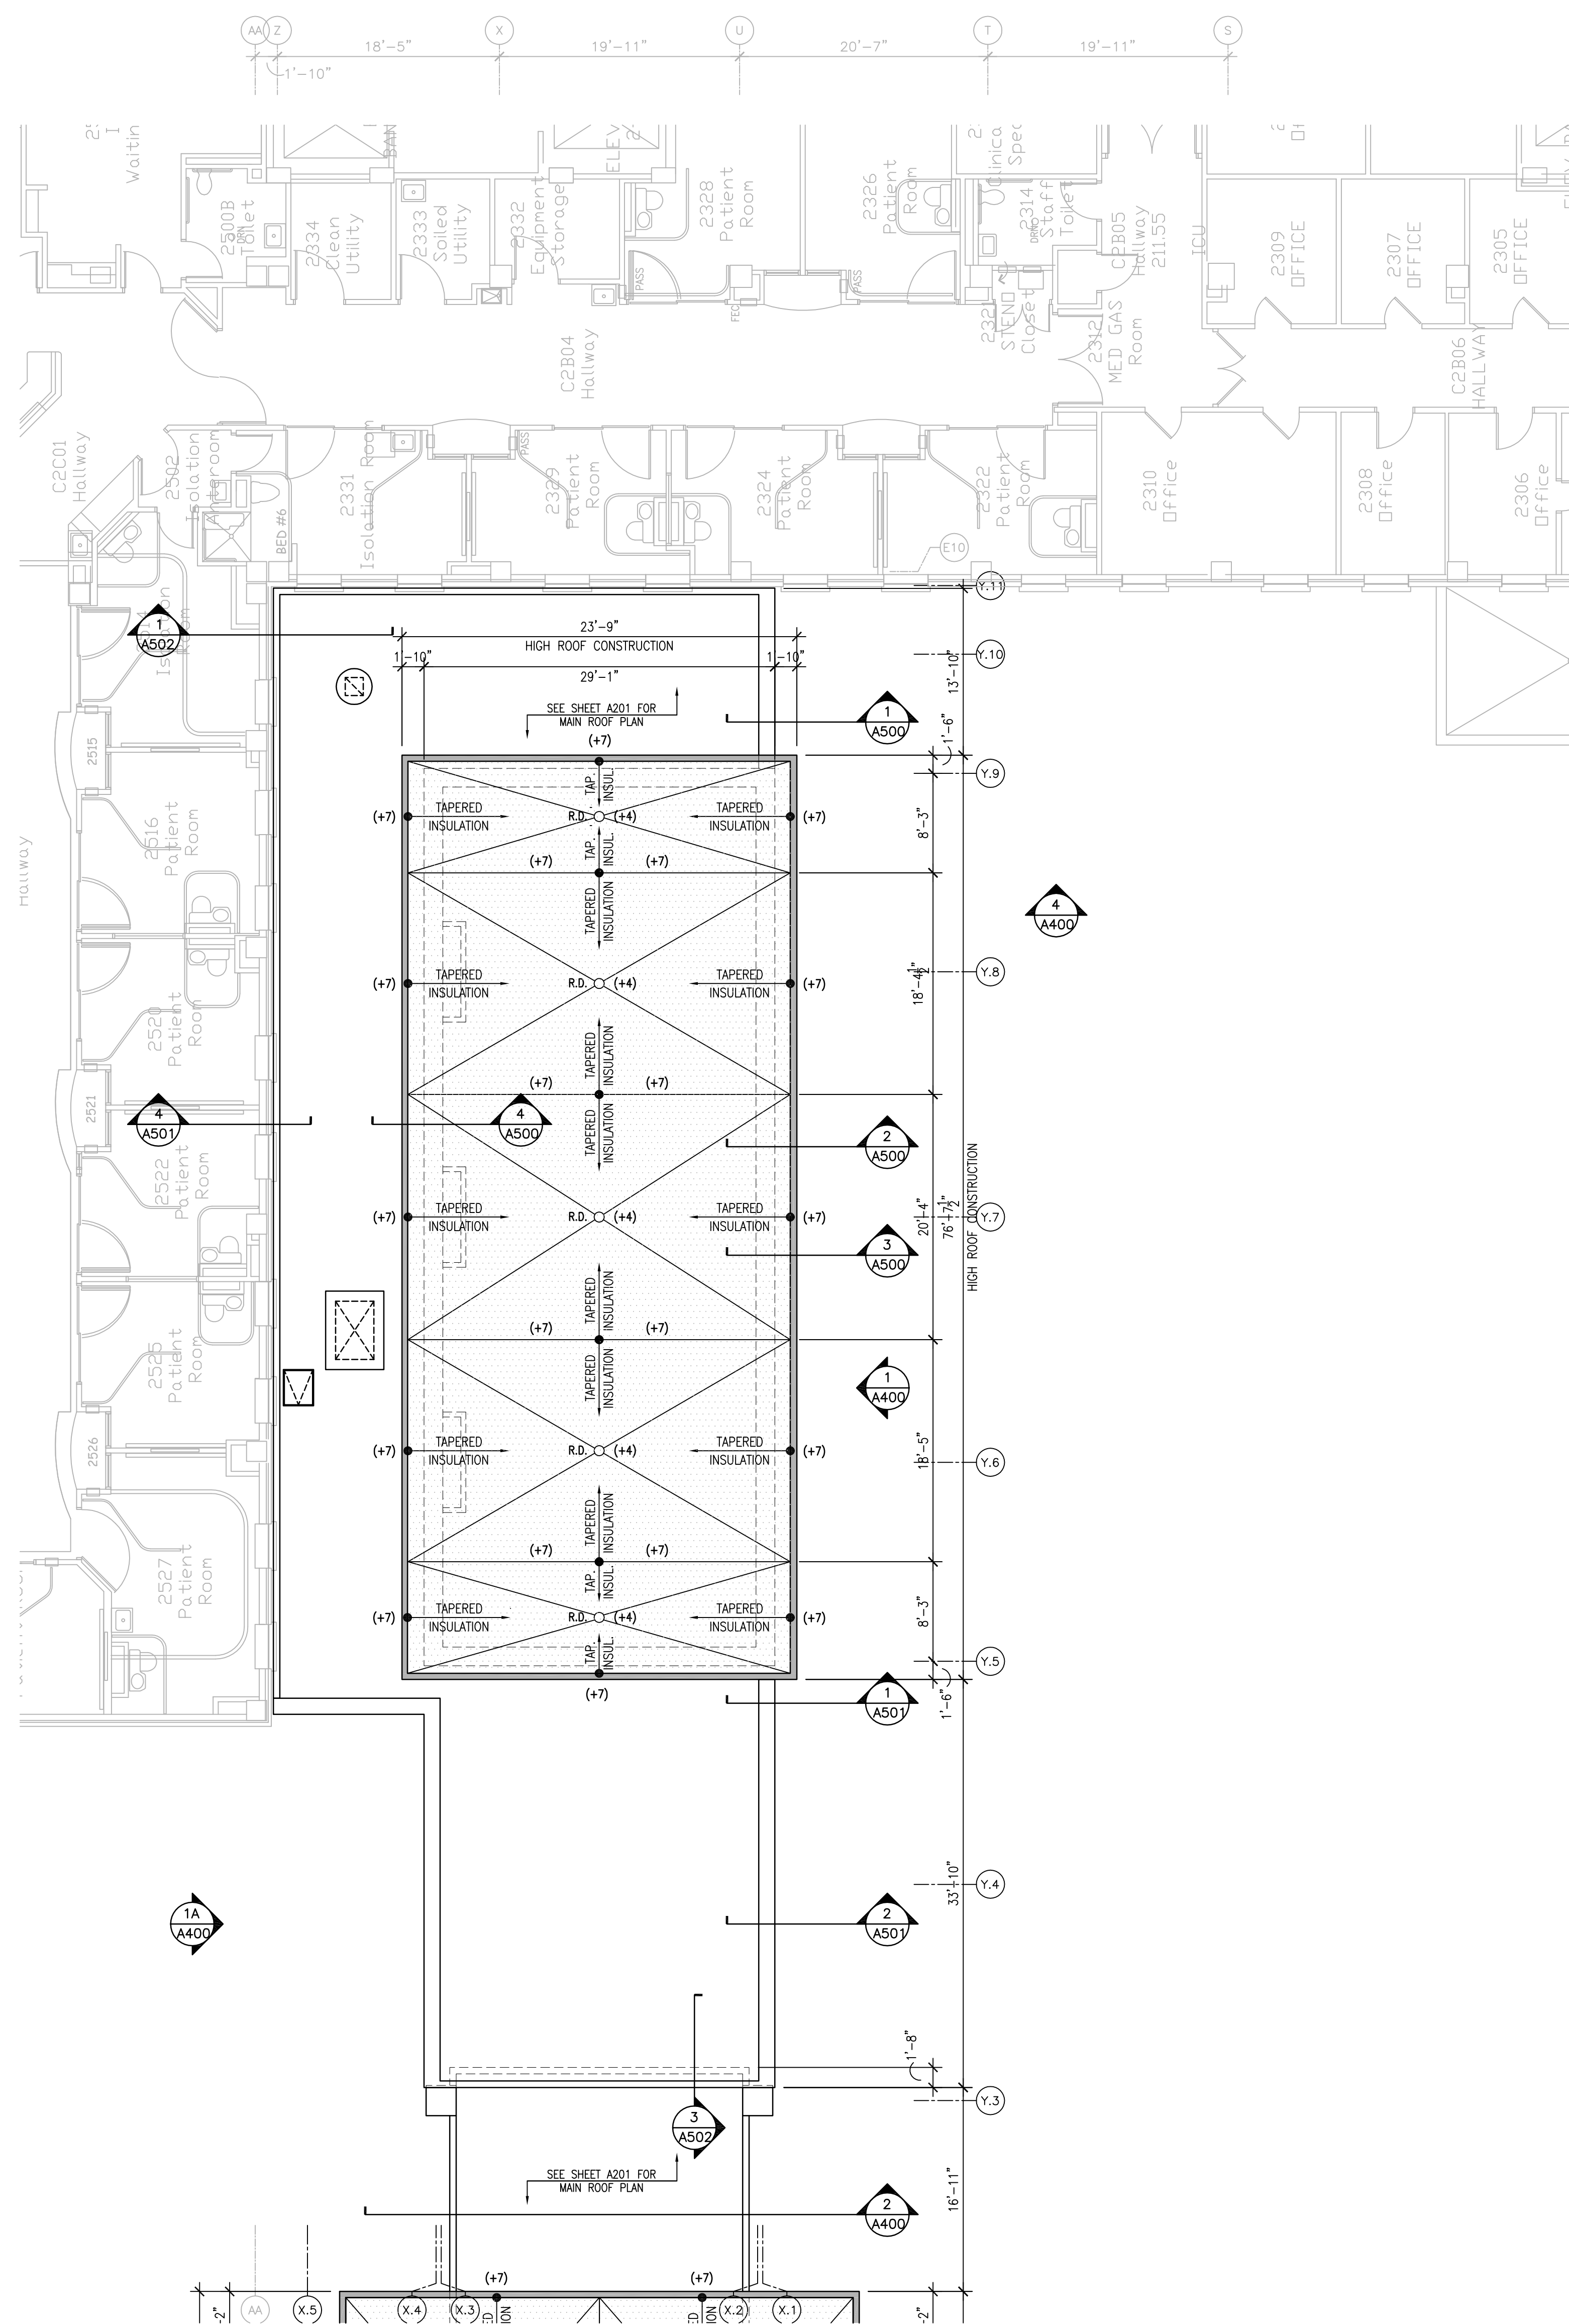




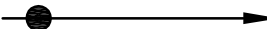



BUILDING 111 - FIRST FLOOR 'ENTRY' CLEARSTORY ROOF PLAN  
SCALE:  $\frac{1}{8}" = 1'-0"$

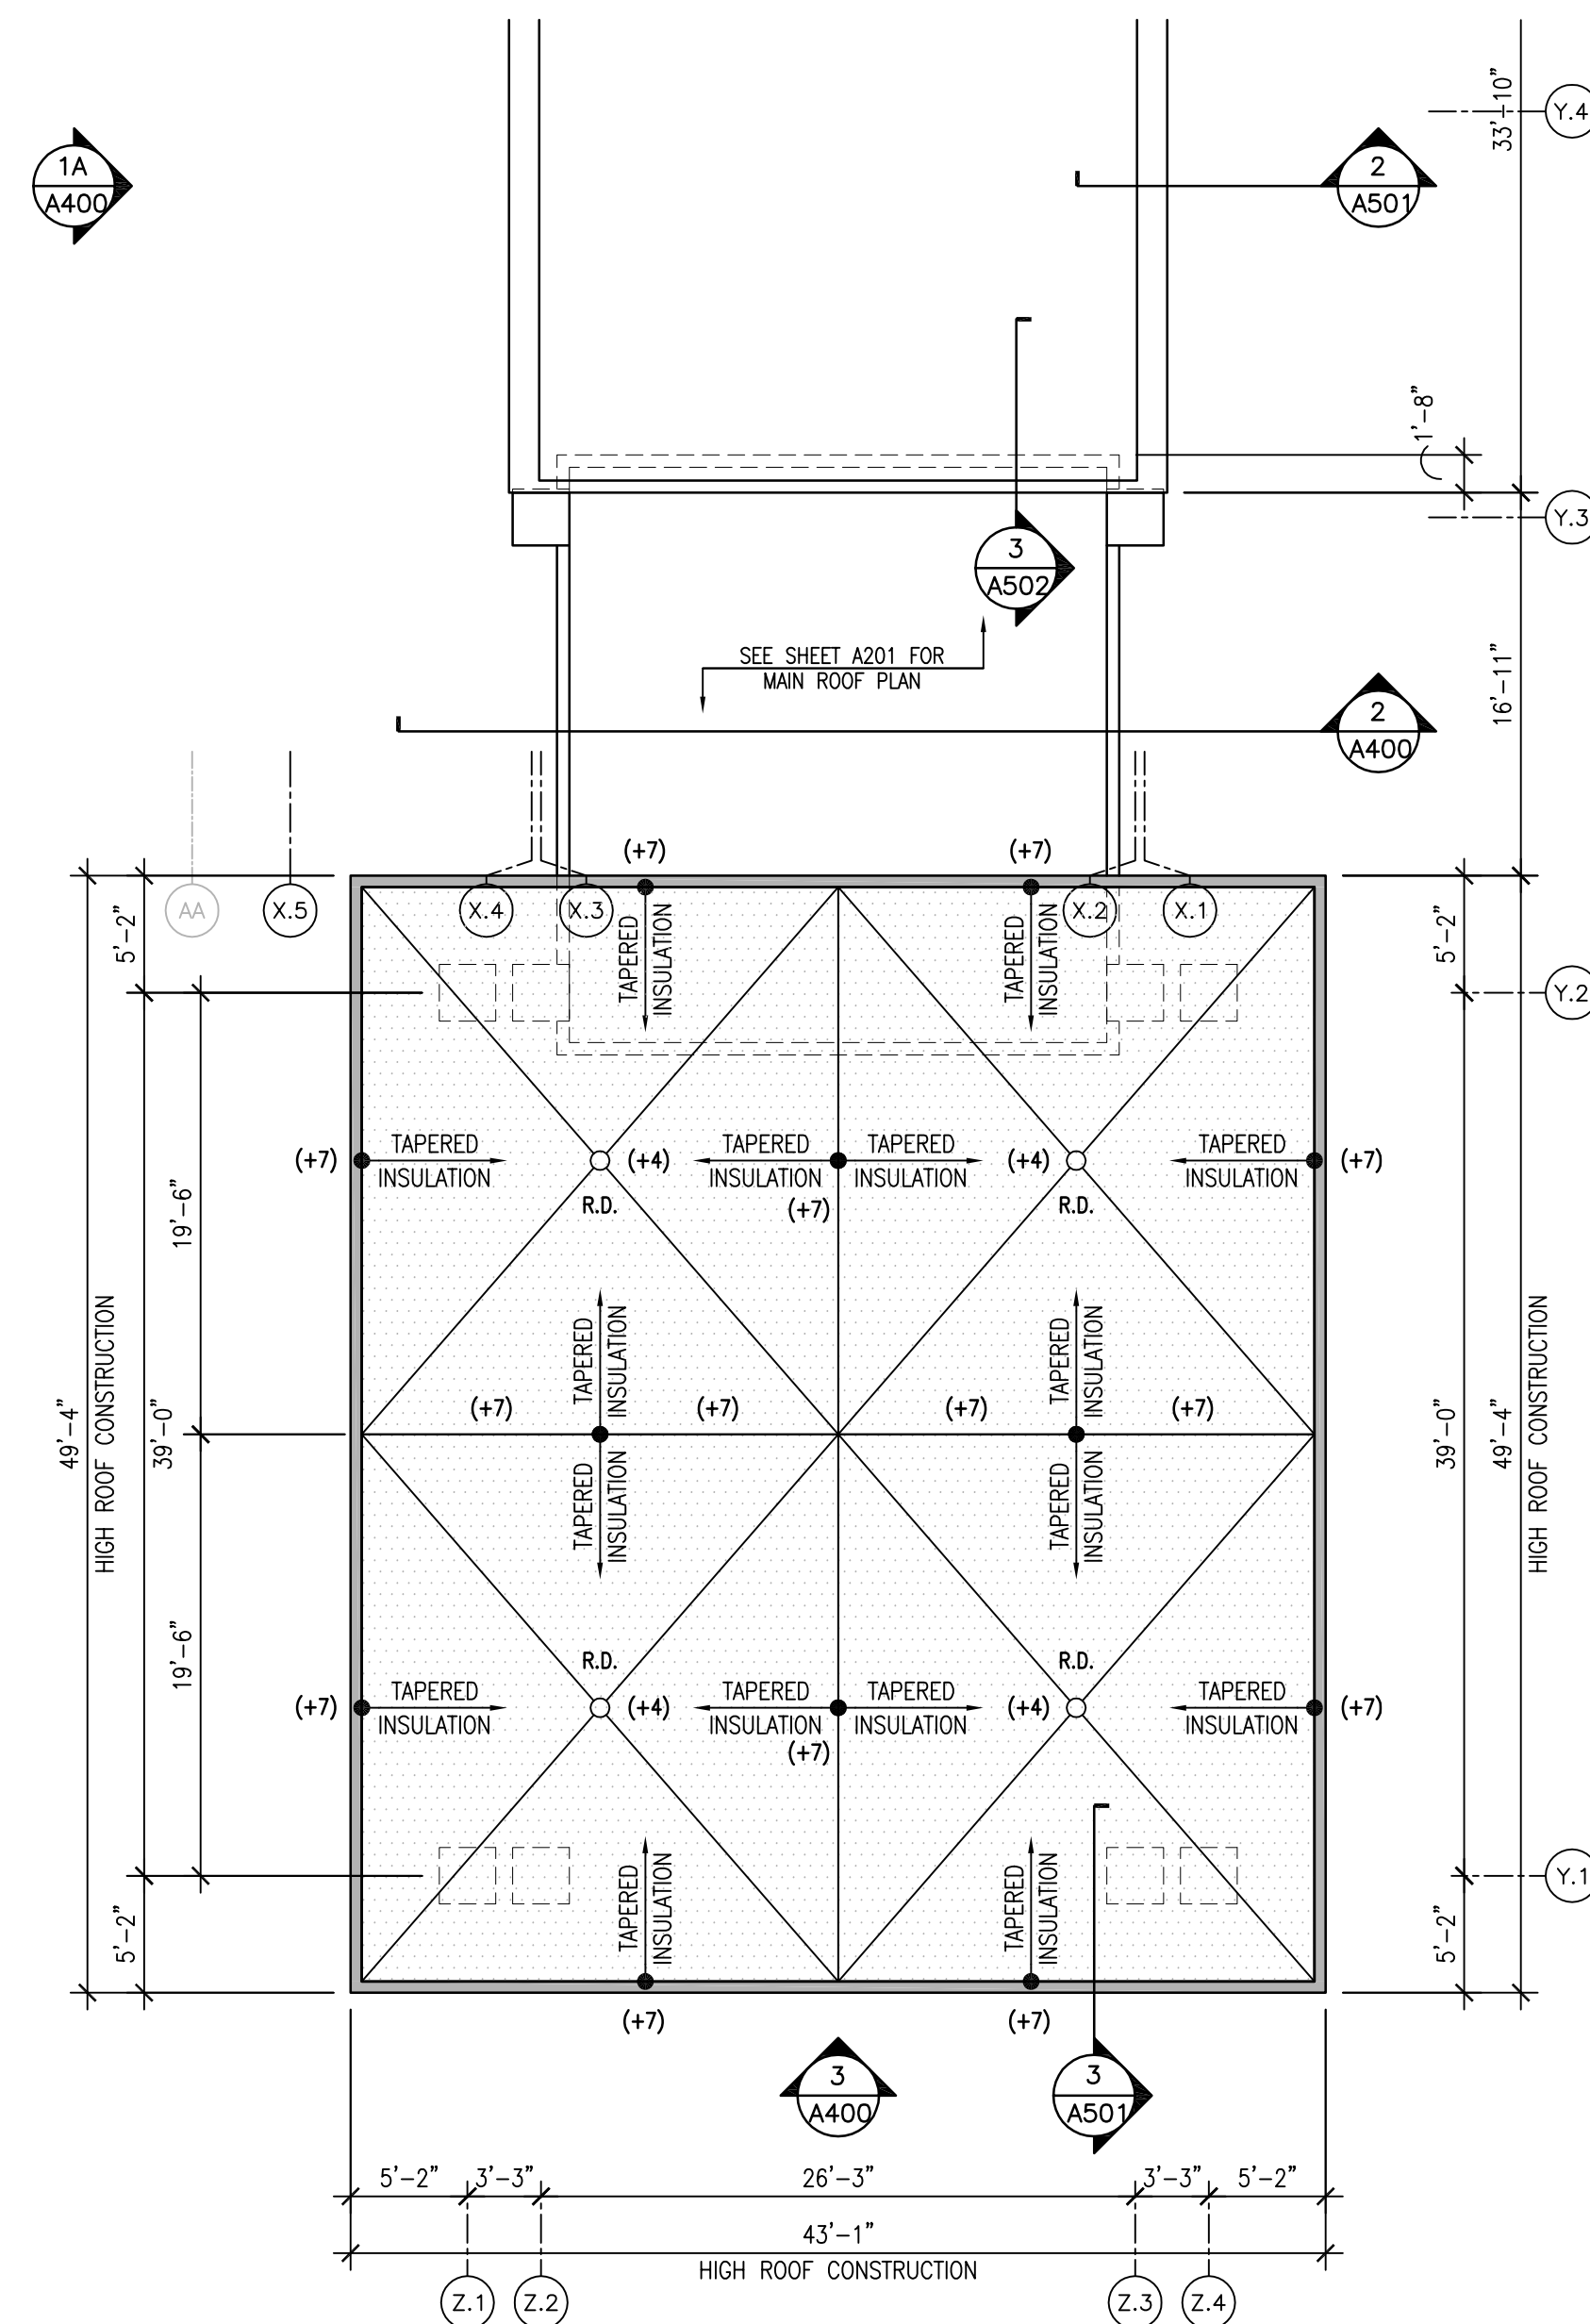

BUILDING 111 - FIRST FLOOR 'CANOPY' CLEARSTORY ROOF PLAN  
SCALE:  $\frac{1}{8}" = 1'-0"$

- ## ROOF PLAN NOTES:
- 
- ALL ROOFING AND INSULATION TO BE INSTALLED PER MANUFACTURER'S DETAILS & REQUIREMENTS. PROVIDE ALL MATERIALS & ACCESSORIES REQUIRED TO PROVIDE A COMPLETE AND WATERTIGHT SYSTEM.
  - PROVIDE AND INSTALL MEMBRANE FORM FLASHING FOR ALL ROOF MEMBRANE PENETRATIONS. INSTALL PER MANUFACTURER'S DETAILS & REQUIREMENTS.
  - SEE MECHANICAL DRAWINGS FOR LOCATION & SIZE OF ALL ROOF PENETRATIONS.
  - SEE MECHANICAL DRAWINGS FOR SIZE, LOCATION, & DETAILS OF ALL REQUIRED EQUIPMENT CURBS.
  - PAINTING CONTRACTOR TO PAINT ALL EXPOSED ROOFING PENETRATIONS — ROOF DUCTWORK, HVAC ROOFTOP UNITS, EXHAUST HOODS, VENTS, CAPS, & ALL OTHER ASSOCIATED MEP ITEMS.

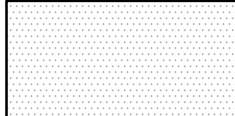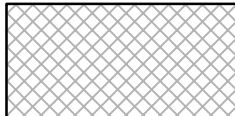
- ## ROOF PLAN LEGEND:
- |  |   |
|--|---|
|       | NEW EPDM ROOFING OVER<br>ROOFING INSULATION @ HIGH ROOF<br>(SEE SPECIFICATIONS) |
|       | NEW EPDM ROOFING OVER<br>ROOFING INSULATION @ LOW ROOF<br>(SEE SPECIFICATIONS)  |
|       | NEW ROOF PARAPET  |
|       | DIRECTION OF SLOPED<br>TAPERED ROOFING INSULATION<br>(1/4" PER FOOT MIN.)       |
| (X)  | THICKNESS OF TAPERED<br>ROOFING INSULATION (INCHES)                             |
|  R.D. | NEW ROOF DRAIN - SEE<br>MEP DRAWINGS  |

[illegible]

Dept. of Veterans Affairs  
Medical Center  
5000 W. National Avenue  
Milwaukee, WI



KEY PLAN: 

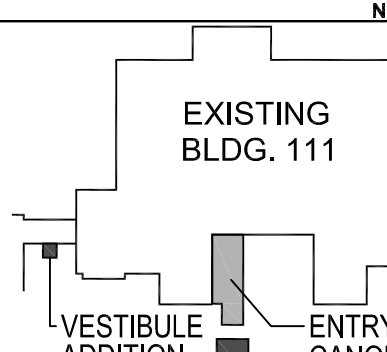

CONSULTANTS:



PROJECT LEADER/ARCHITECT:



Drawing Title	Building 111 - First Floor Entry & Canopy Clearstory Roof Plans
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Approved: Project Director

Project Title	Building 111 - Renovate South Entry
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Location	Milwaukee, Wisconsin
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Checked By	MAC
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Drawn By:  
KJS


FINAL CONSTRUCTION DOCUMENTS

Project Number	695-12-101SCP
Building Number	111
Drawing Number	

Office of  
Facilities  
Management





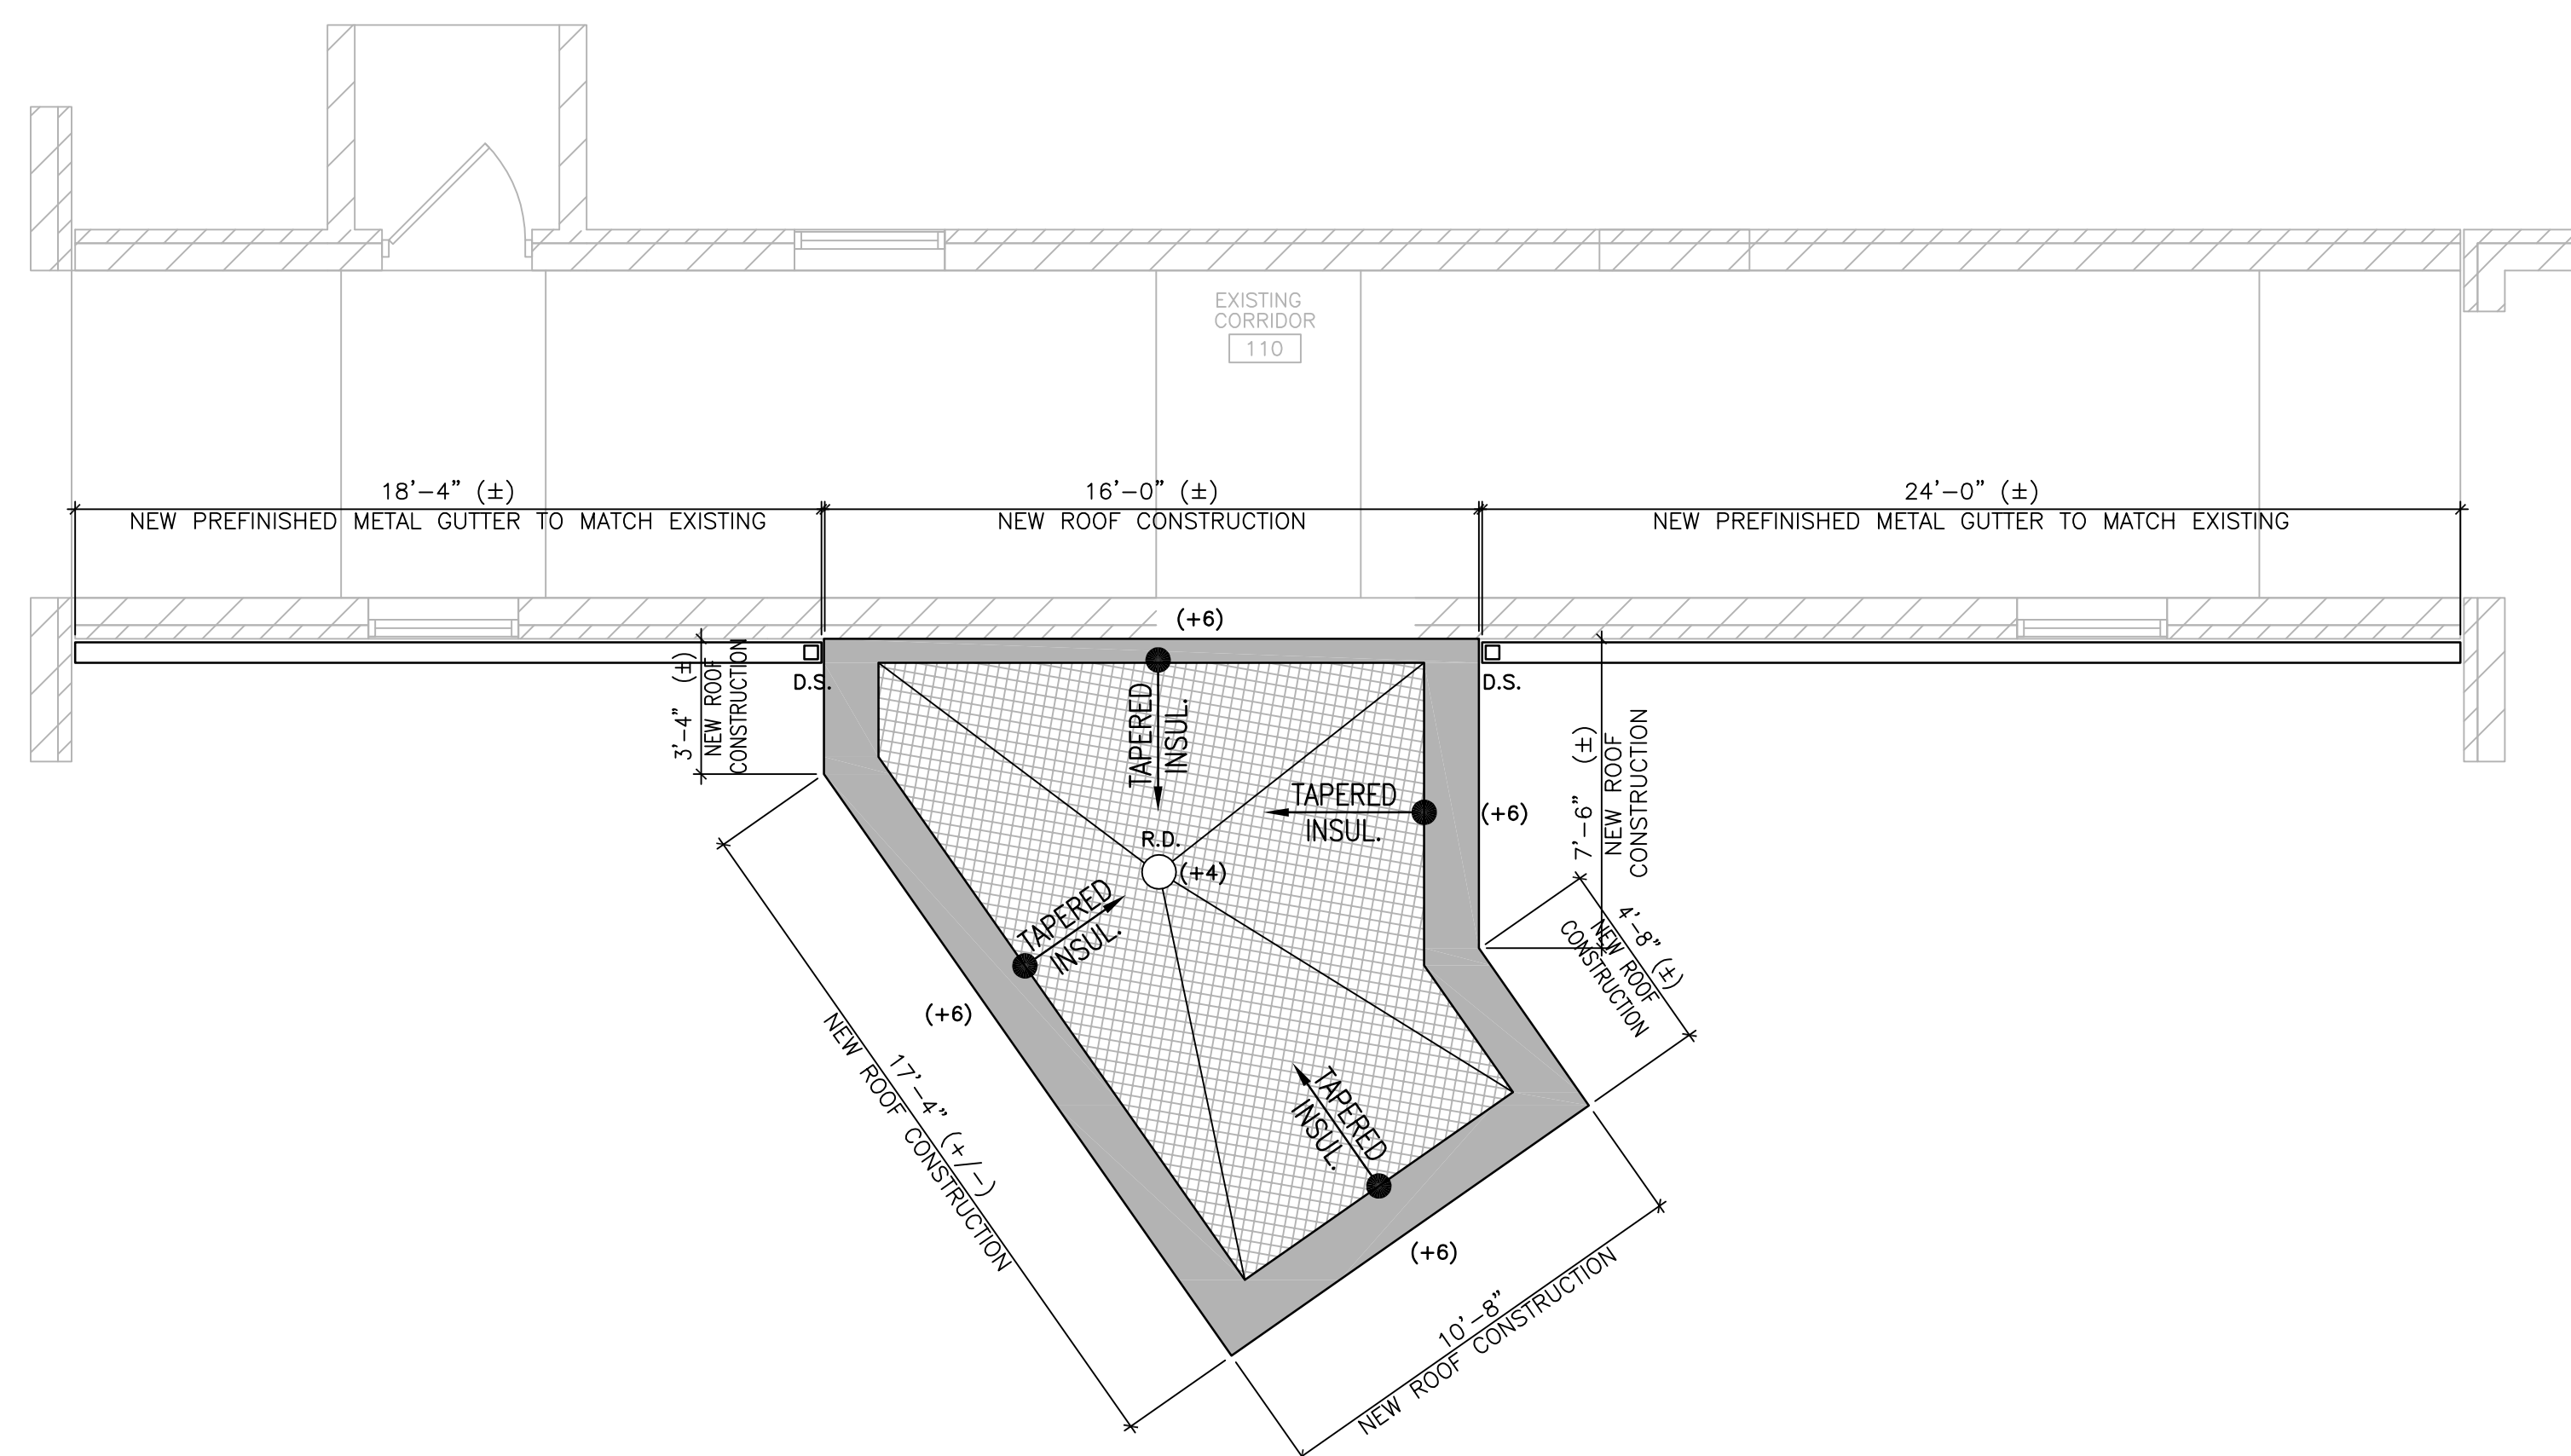








BUILDING 70 - VESTIBULE ADDITION ROOF PLAN  
SCALE: 1/4" = 1'-0"

ROOF PLAN NOTES:

- ALL ROOFING AND INSULATION TO BE INSTALLED PER MANUFACTURER'S DETAILS & REQUIREMENTS. PROVIDE ALL MATERIALS & ACCESSORIES REQUIRED TO PROVIDE A COMPLETE AND WATERTIGHT SYSTEM.
- PROVIDE AND INSTALL MEMBRANE FORM FLASHING FOR ALL ROOF MEMBRANE PENETRATIONS. INSTALL PER MANUFACTURER'S DETAILS & REQUIREMENTS.
- SEE MECHANICAL DRAWINGS FOR LOCATION & SIZE OF ALL ROOF PENETRATIONS.
- SEE MECHANICAL DRAWINGS FOR SIZE, LOCATION, & DETAILS OF ALL REQUIRED EQUIPMENT CURBS.
- PAINTING CONTRACTOR TO PAINT ALL EXPOSED ROOFING PENETRATIONS - ROOF PENETRATIONS TO INCLUDE ALL EXPOSED DUCTWORK, HVAC ROOFTOP UNITS, EXHAUST HOODS, VENTS, CAPS, & ALL OTHER ASSOCIATED MEP ITEMS.

ROOF PLAN LEGEND:


- |  |   |
|--|---|
|       | NEW EPDM ROOFING OVER<br>ROOFING INSULATION @ HIGH ROOF<br>(SEE SPECIFICATIONS) |
|       | NEW EPDM ROOFING OVER<br>ROOFING INSULATION @ LOW ROOF<br>(SEE SPECIFICATIONS)  |
|       | NEW ROOF PARAPET  |
|       | DIRECTION OF SLOPED<br>TAPERED ROOFING INSULATION<br>(1/4" PER FOOT MIN.)       |
| (X)  | THICKNESS OF TAPERED<br>ROOFING INSULATION (INCHES)                             |
|  D.S. | NEW PREFINISHED METAL<br>DOWNSPOUT  |
|  R.D. | NEW ROOF DRAIN - SEE<br>MEP DRAWINGS  |

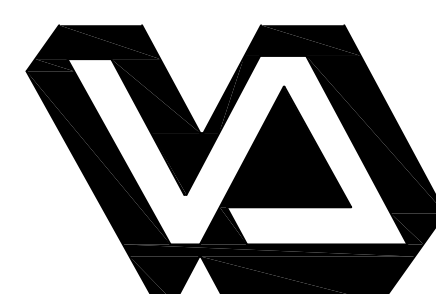[illegible]

Dept. of Veterans Affairs  
Medical Center  
5000 W. National Avenue  
Milwaukee, WI



KEY PLAN:

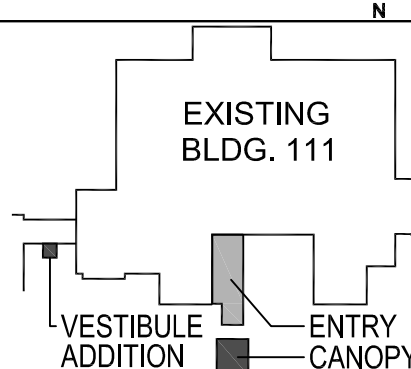

CONSULTANTS:



PROJECT LEADER/ARCHITECT:



Drawing Title	Building 70 - Connecting Corridor Vestibule Addition Roof Plan
---------------	--

Approved: Project Director

Project Title	Building 111 - Renovate South Entry
---------------	--

Location	Milwaukee, Wisconsin
----------	----------------------

Date  
June 23, 2014

Checked By  
MAC

Drawn By:  
KJS

FINAL CONSTRUCTION DOCUMENTS

Project Number	695-12-101SCF
Building Number	111

	Drawing Number

A210

Office of  
Facilities  
Management





three inches = one foot

one and one half inches = one foot

one inch = one foot

three quarters inch = one foot

one half inch = one foot

three eighths inch = one foot

one quarter inch = one foot

one eighth inch = one foot

A


B

C

D

E

F

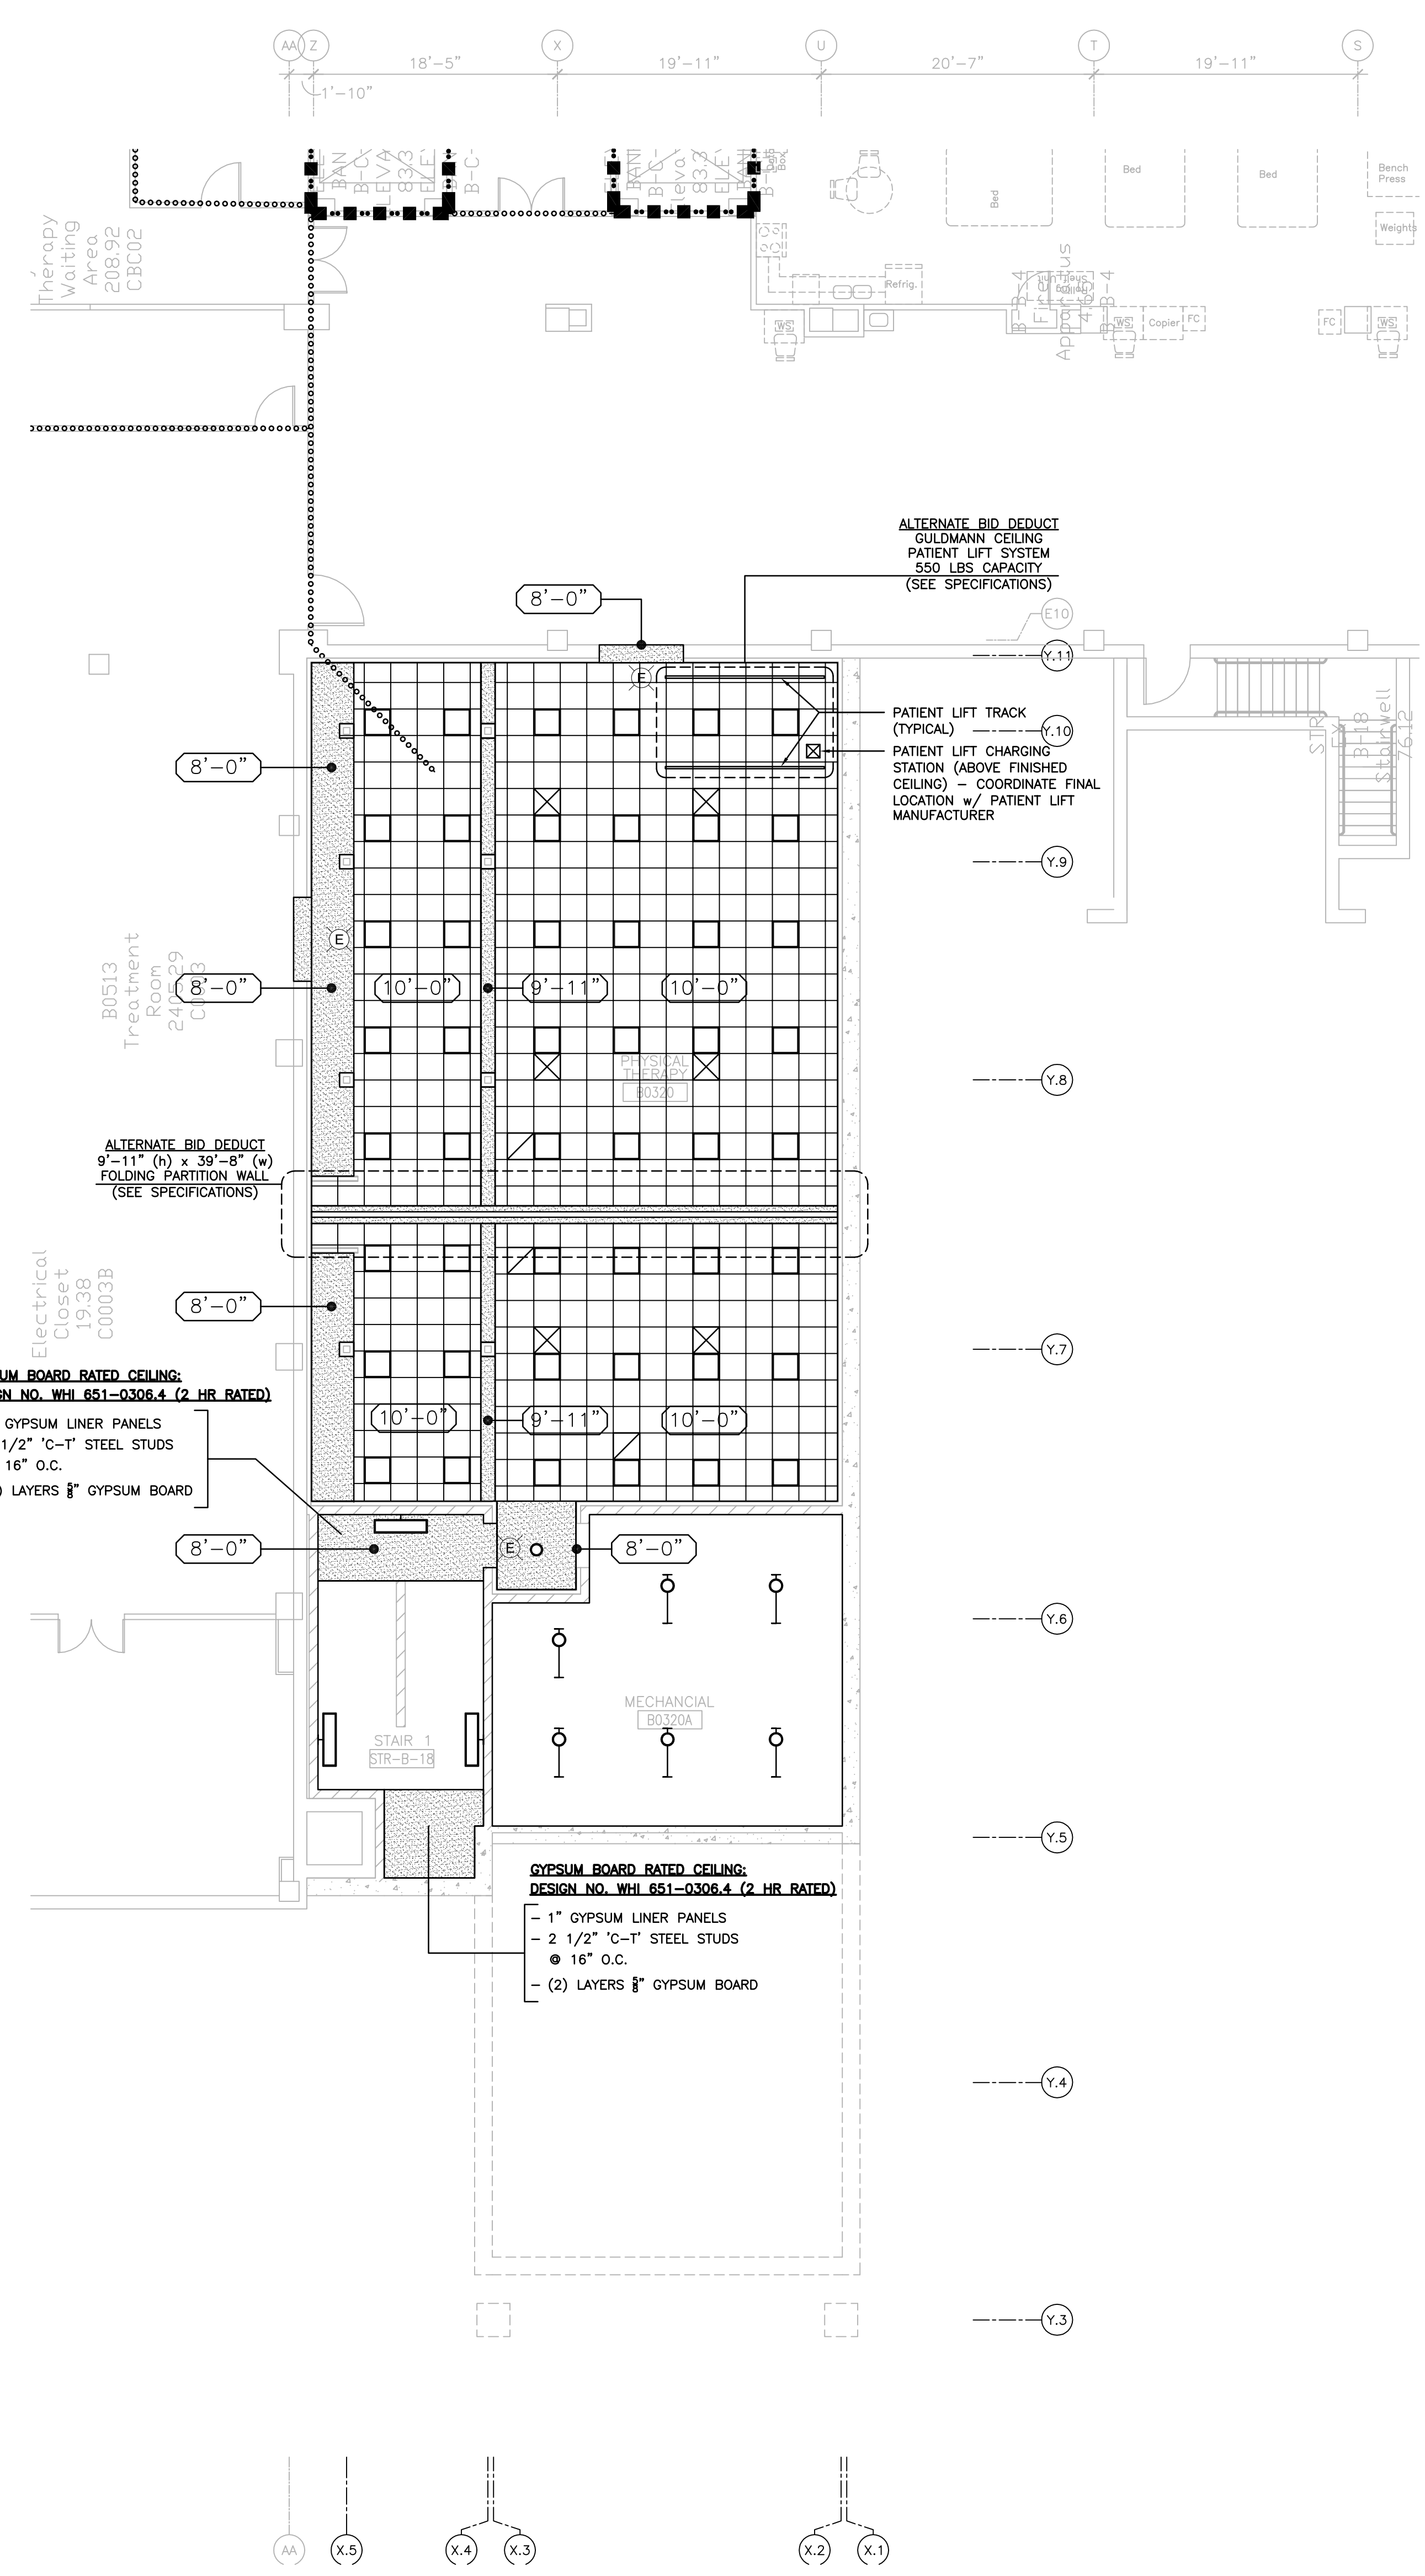

**CEILING PLAN NOTES:**

- GENERAL CONTRACTOR RESPONSIBLE FOR THE COORDINATION OF ALL ABOVE CEILING WORK.
- ALL FINISHED CEILING HEIGHTS TO BE INSTALLED 9'-0" A.F.F. UNLESS NOTED OTHERWISE.
- SEE ROOM FINISH SCHEDULE FOR CEILING FINISHES & SCHEDULED CEILING TYPES.
- SEE ELECTRICAL DRAWINGS FOR LIGHTING FIXTURE LAYOUTS & SPECIFICATIONS.
- SEE HVAC DRAWINGS FOR CEILING DIFFUSER LAYOUTS & SPECIFICATIONS.

**CEILING PLAN LEGEND:**

	ACOUSTICAL LAY-IN CEILING
	DROPPED GYPSUM BOARD CEILING
	EXTERIOR FINISH SYSTEM (E.I.F.S.)
	FINISHED CEILING HEIGHT
	CEILING TRANSFER, RETURN, OR EXHAUST GRILLE - SEE MECHANICAL DRAWINGS
	CEILING SUPPLY GRILLE - SEE MECHANICAL DRAWINGS
	RECESSED LIGHT FIXTURE - SEE ELECTRICAL DRAWINGS
	WALL-MOUNT FIXTURE - SEE ELECTRICAL DRAWINGS
	CEILING-MOUNT FIXTURE - SEE ELECTRICAL DRAWINGS
	RECESSED CAN LIGHT FIXTURE - SEE ELECTRICAL DRAWINGS
	EMERGENCY EXIT LIGHT - SEE ELECTRICAL DRAWINGS
	FIRE SPRINKLER HEAD - SEE FIRE PROTECTION DRAWINGS

BUILDING 111 - FIRST FLOOR 'ENTRY' REFLECTED CEILING PLAN  
SCALE: 1/8" = 1'-0"

Revisions:

Date

Dept. of Veterans Affairs  
Medical Center  
5000 W. National Avenue  
Milwaukee, WI

KEY PLAN:

CONSULTANTS:

RING & DUCHATEAU

R.A. Smith National

PROJECT LEADER/ARCHITECT:

Chequamegon

Drawing Title

Building 111 - Lower Level Entry Reflected Ceiling Plan

Project Title

Building 111 - Renovate South Entry

Location

Milwaukee, Wisconsin

Date

June 23, 2014

Checked By:

MAC

Drawn By:

KJS

Project Number

695-12-101SCP

Building Number

111



Drawing Number

A300




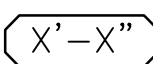
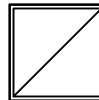
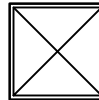

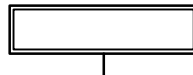
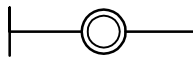



Office of Facilities Management

Department of Veterans Affairs

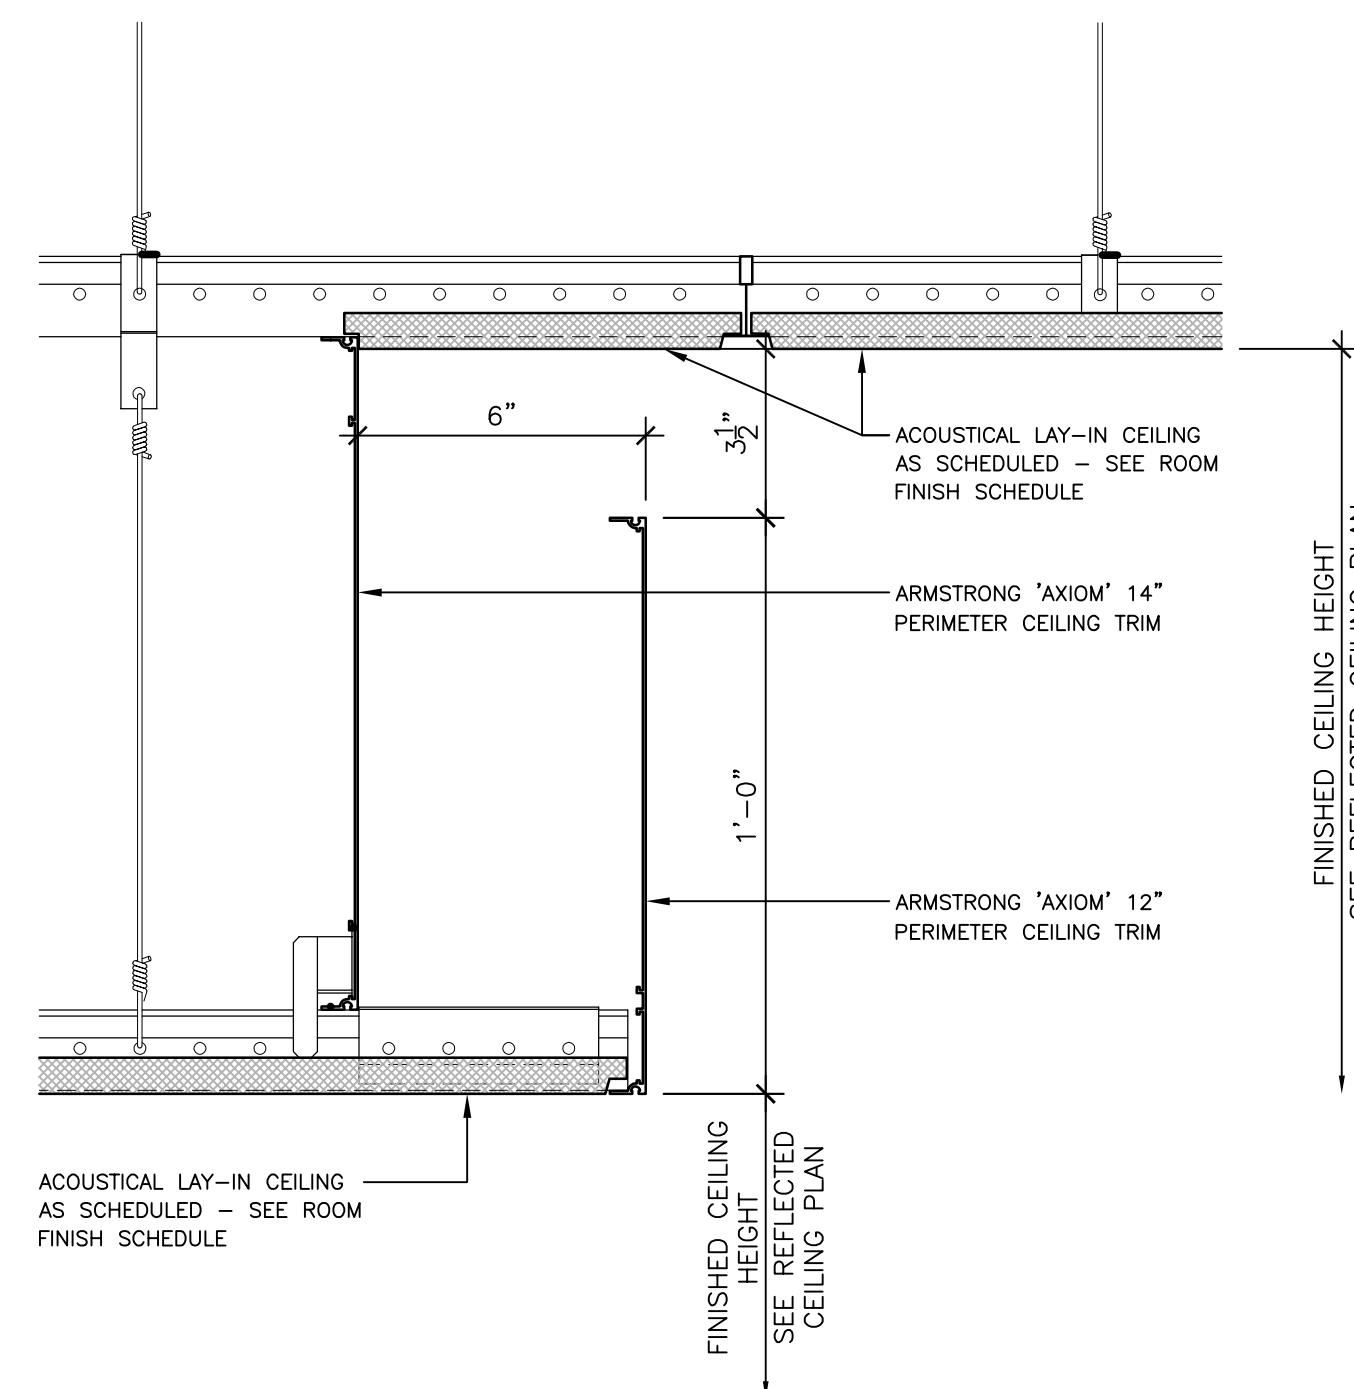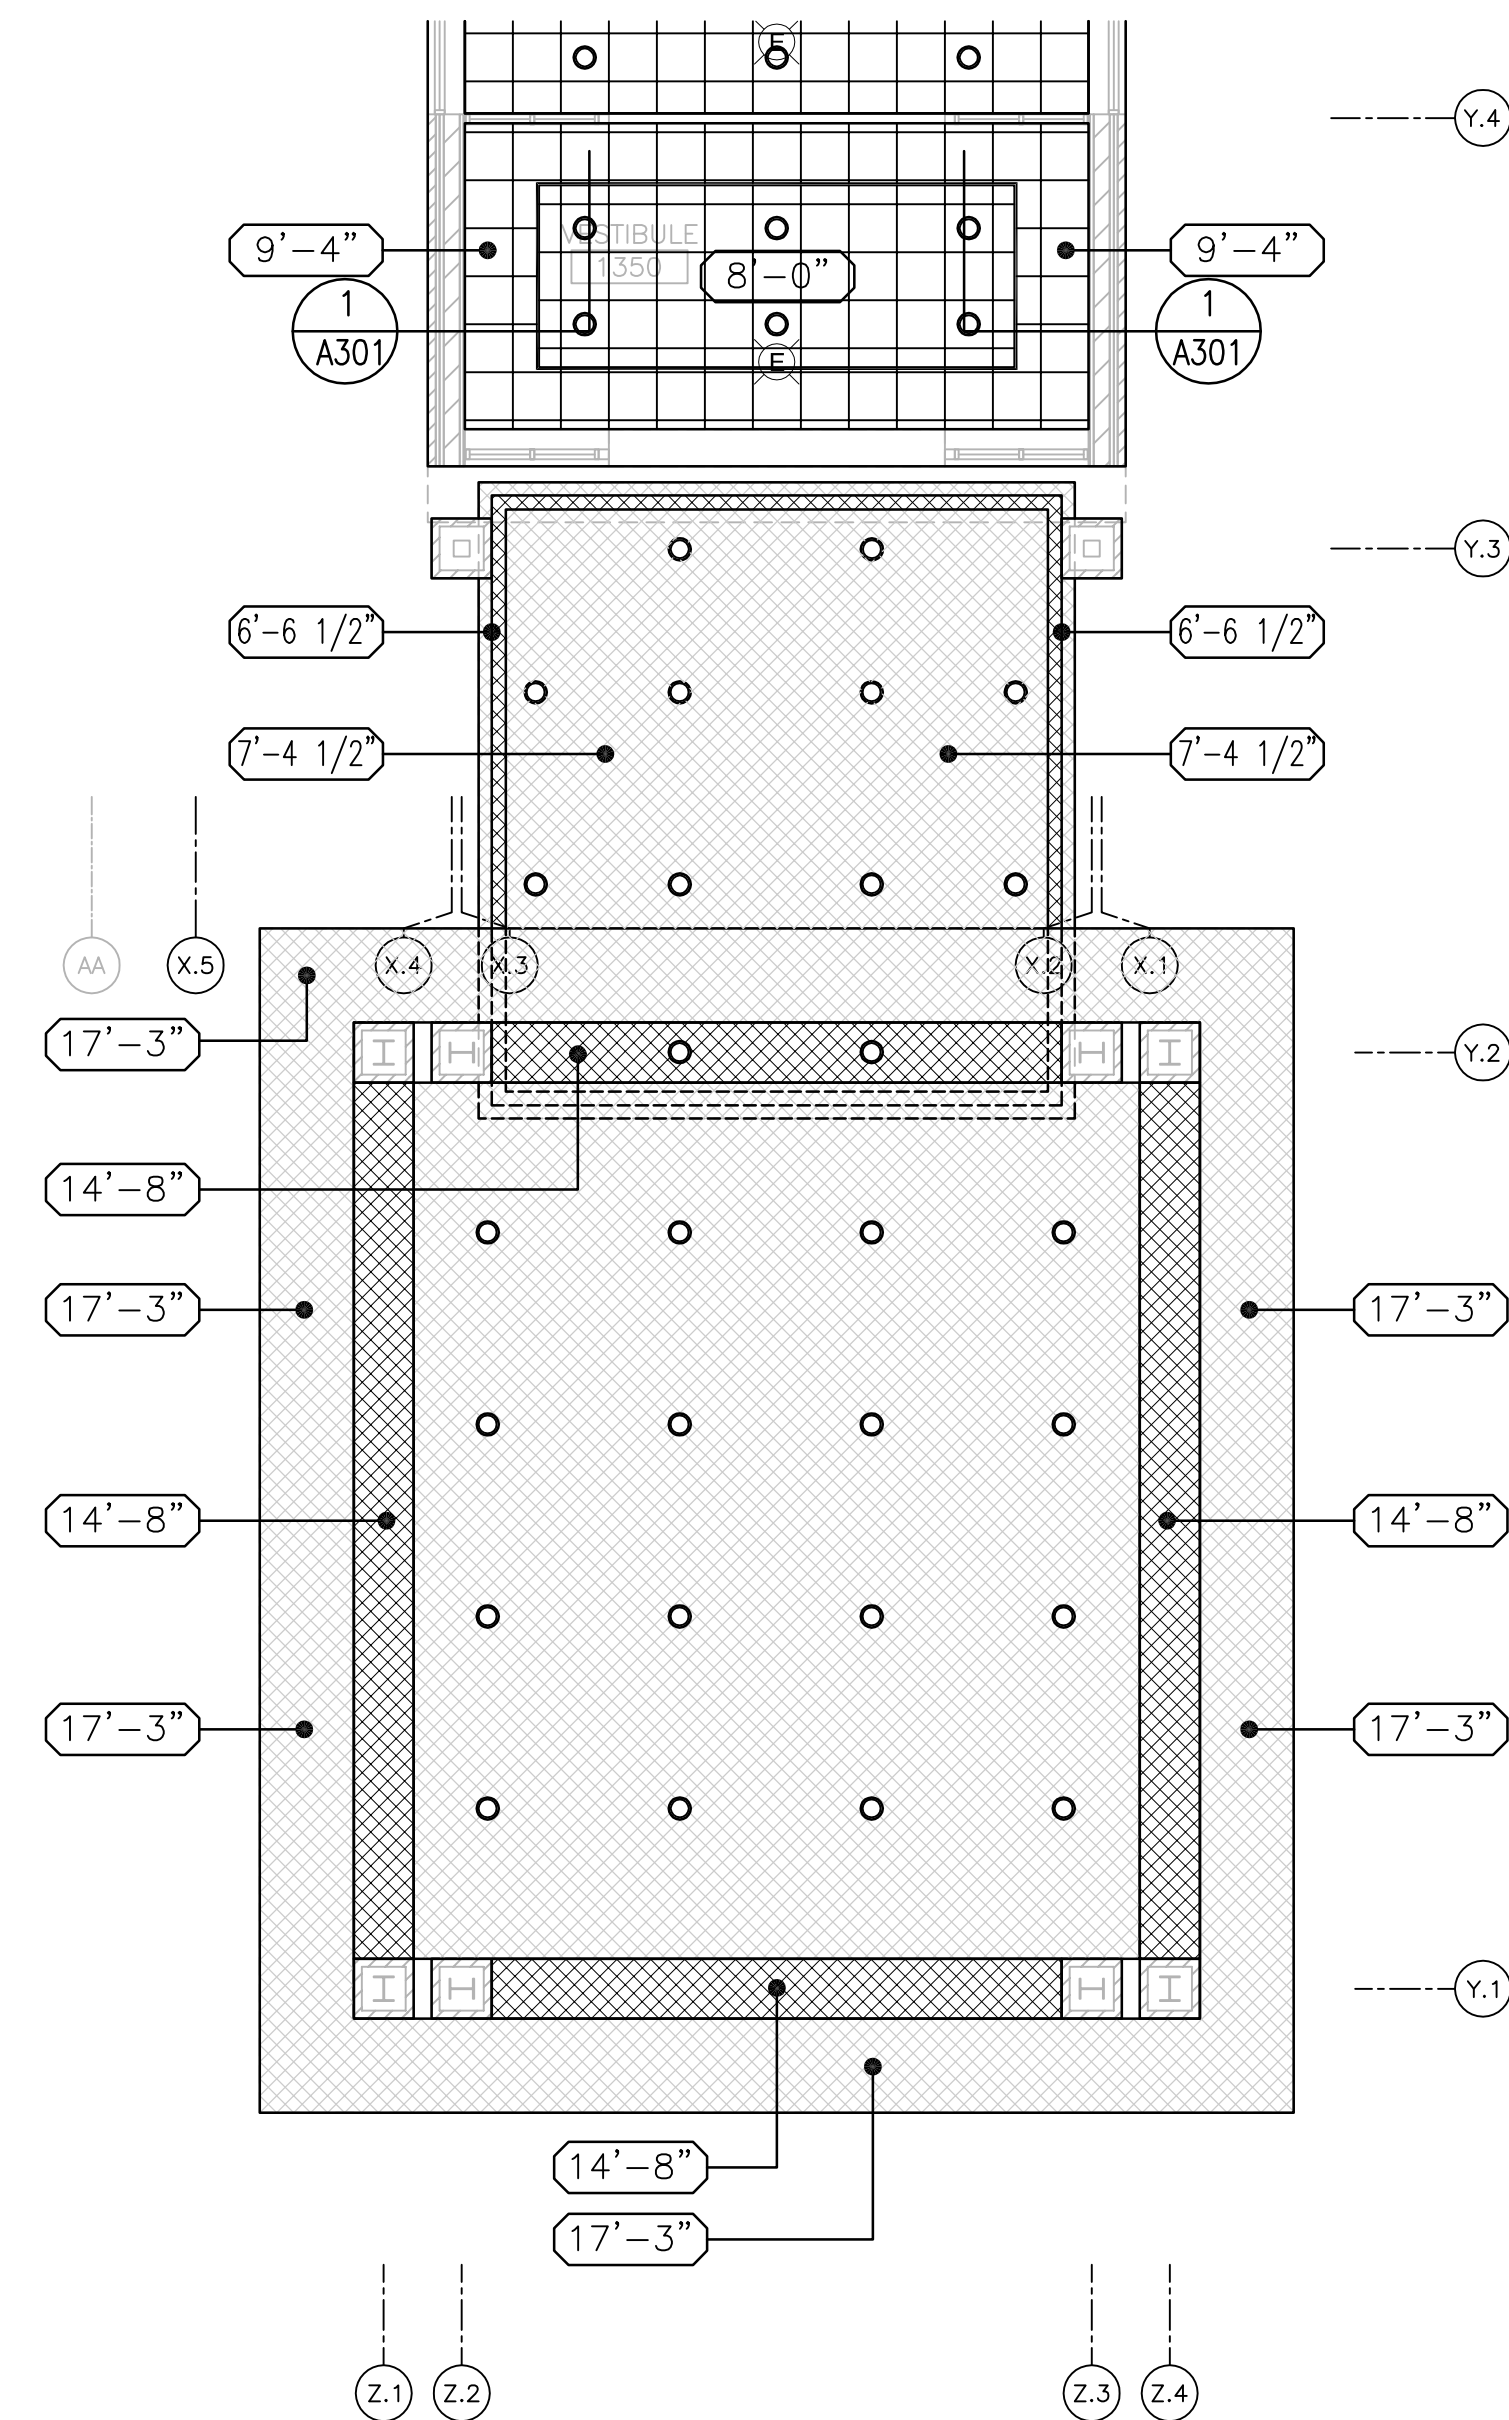

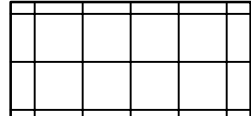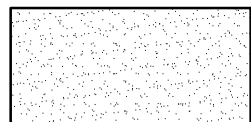

- ## CEILING PLAN NOTES:
- GENERAL CONTRACTOR RESPONSIBLE FOR THE COORDINATION OF ALL ABOVE CEILING WORK.
  - ALL FINISHED CEILING HEIGHTS TO BE INSTALLED 9'-0" A.F.F. UNLESS NOTED OTHERWISE.
  - SEE ROOM FINISH SCHEDULE FOR CEILING FINISHES & SCHEDULED CEILING TYPES.
  - SEE ELECTRICAL DRAWINGS FOR LIGHTING FIXTURE LAYOUTS & SPECIFICATIONS.
  - SEE HVAC DRAWINGS FOR CEILING DIFFUSER LAYOUTS & SPECIFICATIONS.

- | CEILING PLAN LEGEND:  |   |
|---|---|
|    | ACOUSTICAL LAY-IN CEILING   |
|    | DROPPED GYPSUM BOARD CEILING  |
|    | EXTERIOR FINISH SYSTEM (E.I.F.S.)   |
|    | FINISHED CEILING HEIGHT<br>(RELATIVE TO F.F.E. = 66.3'-6")                  |
|    | CEILING TRANSFER, RETURN,<br>OR EXHAUST GRILLE - SEE<br>MECHANICAL DRAWINGS |
|    | CEILING SUPPLY GRILLE -<br>SEE MECHANICAL DRAWINGS                          |
|    | RECESSED LIGHT FIXTURE -<br>SEE ELECTRICAL DRAWINGS                         |
|    | WALL-MOUNT FIXTURE -<br>SEE ELECTRICAL DRAWINGS                             |
|    | CEILING-MOUNT FIXTURE -<br>SEE ELECTRICAL DRAWINGS                          |
|    | RECESSED CAN LIGHT FIXTURE -<br>SEE ELECTRICAL DRAWINGS                     |
|    | EMERGENCY EXIT LIGHT -<br>SEE ELECTRICAL DRAWINGS                           |
|  | FIRE SPRINKLER HEAD -<br>SEE FIRE PROTECTION DRAWINGS                       |


- CEILING PLAN KEY NOTES:**


  - ① NEW CEILING HEIGHT IN EXISTING RENOVATED LOBBY SPACE TO MATCH EXISTING FINISH HEIGHT. FIELD VERIFY PRIOR TO INSTALLATION.
  - ② 30" X 36" ROOF ACCESS HATCH & FIXED LADDER. SEE DETAIL 3/A510.

[illegible]

Dept. of Veterans Affairs  
Medical Center  
5000 W. National Avenue  
Milwaukee, WI



**KEY PLAN:** 



EXISTING BLDG. 111

VESTIBULE ADDITION

ENTRY CANOPY

CONSULTANTS:

 RING & DUCHATEAU	 R.A. Smith National
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PROJECT LEADER/ARCHITECT:



Chequamegon  
Bay Group, Inc.

AS-BAND, WI • MILWAUKEE, WI • MADISON, WI • DULUTH, MN  
(715) 482-3204 (414) 238-4354 (608) 233-8942 (218) 728-4293

[WWW.CHEQUAMEGON.COM](http://WWW.CHEQUAMEGON.COM)

Drawing Title	Building 111 - First Floor Entry & Canopy Reflected Ceiling Plans
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Approved: Project Director

Project Title	Building 111 - Renovate South Entry
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Location	Milwaukee, Wisconsin
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Date  
June 23, 2014

Checked By:  
**MAC**

Drawn By:  
KJS

FINAL CONSTRUCTION DOCUMENTS

Project Number 695-12-101SCP	
Building Number 111	

Drawing Number

A301

Office of  
Facilities  
Management





